


ISSUED FOR BUILDING PERMIT - COMMERCIAL PROPOSED INTERIOR RENOVATIONS TO THE BERMUDA POST OFFICE GROUND FLOOR AND BASEMENT

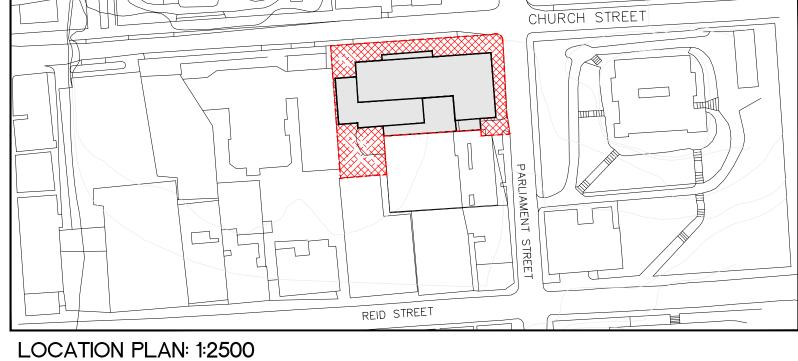

DRAWING INDEX

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GOVERNMENT POST OFFICE BUILDING Prepared by

MINISTRY OF PUBLIC WORKS ARCHITECTS & DESIGN SECTION

FOR **MINISTRY OF NATIONAL SECURITY BERMUDA POST OFFICE**

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Sheet Title: TITLE SHEET

56 CHURCH STREET GROUND & BASEMENT LEVEL CITY OF HAMILTON BERMUDA

RELOCATION OF PARCEL POST PROCESSING FUNCTION'S

Project Title:

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WASTE MANAGEMENT NOTES:

- WOOD PRODUCTS EXCEPT THOSE THAT PRODUCE UNDESIRABLE EMISSIONS) SHALL BE DELIVERED TO THE TYNES BAY WASTE TREATMENT FACILITY.
- 2. ALL WASTE SUITABLE FOR A COVER MATERIAL SHALL BE DELIVERED TO THE PEMBROKE DUMP.
- 3. ALL METAL, PVC, GYPSUM BOARD SHALL BE DELIVERED TO THE AIRPORT WASTE MANAGEMENT FACILITY.
- 4. ANY HAZARDOUS WASTE, SUCH AS PRODUCTS CONTAINING MERCURY (LIKE FLUORESCENT LAMPS MERCURY SWITCHES) PCB'S (LIGHT BALLASTS, TRANSFORMERS), OTHER CHEMICALS (PESTICIDES, OILS) SHALL NOT BE ACCEPTED AT ANY FACILITY, EXCEPT DURING HAZARDOUS WASTE DROP OFF DAYS OR BY PRIOR ARRANGEMENT WITH THE WASTE MANAGEMENT SECTION OF THE MINISTRY OF WORKS AND ENGINEERING.
- MISCELLANEOUS METAL SUCH AS DOOR FRAMES, WINDOW FRAMES, WITH OR WITHOUT GLASS, SHALL BE DELIVERED TO THE AIRPORT DUMP SITE.
- 6. ALL WHITE GOODS, SMALL APPLIANCES, TV SETS, ETC. SHALL BE CLEARED OF CONTAMINANTS SUCH AS MERCURY, PCB, REFRIGERANTS, OILS, ETC. THEY SHALL BE CRATED OR FLATTENED BEFORE DELIVERY TO THE AIRPORT SITE.
- ALL UNSALVAGEABLE LUMBER IS TO BE STRIPPED OF PLASTER, EXPANDED WIRE MESH, STEEL ATTACHMENTS (EG. DOOR KNOBS, LOCK SETS, HINGES). ETC. (SMALL NAILS ARE ACCEPTABLE). THE LUMBER SHALL BE DELIVERED TO THE TYNES BAY SITE IN A SIZE READY FOR INCINERATION (CHIPPED TO SMALL PIECES, SAY 3"X 3"X 3") OR LARGER SIZES (LESS THAN 3"X 6"X 5') MAY BE STORED BY THE CONTRACTOR AND DELIVERED TO THE TYNES BAY SITE BY PRIOR ARRANGEMENT WITH THE MANAGER OF THE TYNES BAY SITE. ALTERNATIVELY, THE CONTRACTOR MAY APPLY TO THE MINISTRY OF ENVIRONMENT FOR PERMISSION TO BURN LUMBER.
- 8. ALL PLASTER, PLASTER LATH, ETC. AND ASSOCIATED EXPANDED METAL MESH SHALL BE SIZED TO MANAGEABLE DIMENSIONS AND DELIVERED NOT MIXED WITH OTHER DEMOLITION WASTE TO THE AIRPORT SITE
- CARPETS SHALL BE STRIPPED FROM THE SITE, ROLLED INTO SIZE NOT EXCEEDING 10" IN DIAMETER AND 10" IN LENGTH AND SHALL BE DELIVERED TO THE TYNES BAY SITE. GENERAL CONTRACTOR TO MAKE ARRANGEMENTS WITH FACILITY MANAGEMENT PRIOR TO DROP-OFF.
- 10. ALL WOODEN FURNITURE/MILLWORK IS TO BE AS FREE OF METAL AS PRACTICAL AND TRANSPORTED TO THE TYNES BAY SITE.
- 11. FURNITURE MADE OF POLYVINYL CHLORIDE (PVC) SHALL BEDELIVERED TO THE AIRPORT SITE.

GENERAL NOTES:

- 1. IT IS THE GENERAL CONTRACTOR'S RESPONSIBILITY TO: -USE FIGURE DIM. IN PREFERENCE TO SCALING -VERIFY AND CHECK ALL DIMENSIONS PRIOR AND DURING CONSTRUCTION AND BEFORE ORDERING MATERIALS. -DETERMINE THE LOCATION OF EXISTING SERVICES AND REQUIRED CHANGES VERIFY ALL EXISTING CONDITIONS FOR COORDINATION OF WORK TO BE EXECUTED -TO REPORT ANY DISCREPANCIES OR SUBSTITUTIONS TOBE REVIEWED BY THE PROJECT MANAGER BEFORE PROCEEDING. NO SUBSTITUTIONS SHALL BE MADE THAT HAVE NOT BEEN APPROVED PRIOR TO CONTRACT SIGNING.
- 2. THE CONTRACTOR SHALL OBTAIN AND PAY FOR ANY PERMITS, EXCEPT THE BUILDING PERMIT, INCLUDING WORK PERMITS FOR FOREIGN SUB-CONTRACTORS AND INSPECTIONS REQUIRED BY THE APPROPRIATE AUTHORITY TO ALLOW WORK TO PROCEED AND AS APPLICABLE FOR OCCUPANCY. THE CONTRACTOR WILL ALSO BE RESPONSIBLE TO ARRANGE FOR ANY REQUIRED INSPECTIONS BY THE AUTHORITIES HAVING JURISDICTION OVER THE PROJECT.
- 3. ALL WORK SHALL BE CARRIED OUT IN ACCORDANCE WITH ACCEPTABLE TRADE PRACTICES FOR PROJECTS OF THIS NATURE, AND SHALL CONFORM TO ALL CURRENT LAWS, RULES REGULATIONS AND CODE REQUIREMENTS APPLICABLE TO THE WORK REQUIRED BY THE AUTHORITIIES HAVING JURISDICTION OVER THE PROJECT.
- 4. THE CONTRACTOR SHALL CONFORM TO THE LOCAL BUILDING CODES, LATEST EDITION, UL STANDARDS WHERE APPLICABLE, AND STANDARDS FOR THE PRESERVATION OF PUBLIC HEALTH AND CONSTRUCTION SAFETY, WHICH ARE, OR BECOME, IN FORCE DURING THE PERFORMANCE OF THE WORK. THE BERMUDA LAW SHALL GOVERN THIS CONTRACT.
- IN THE EVENT OF CONFLICTS BETWEEN CONTRACT DOCUMENTS THE FOLLOWING SHALL APPLY: (A) FIGURED DIMENSIONS SHOWN ON A DRAWING SHALL GOVERN EVEN THOUGH THEY MAY DIFFER FROM DIMENSIONS SCALED ON THE SAME DRAWING (B) DRAWINGS OF LARGER SCALE SHALL GOVERN OVER THOSE OF SMALLER SCALE OF THE SAME DATE. (C) SPECIFICATIONS SHALL GOVERN OVER DRAWINGS, (D) THE GENERAL CONDITIONS SHALL GOVERN OVER SPECIFICATIONS, (E) SUPPLEMENTARY CONDITIONS SHALL GOVERN OVER THE GENERAL CONDITIONS, AND
- (F) THE EXECUTED AGREEMENT BETWEEN THE OWNER AND THE CONTRACTOR SHALL GOVERN OVER ALL DOCUMENTS.
- NOTWITHSTANDING THE FOREGOING, DOCUMENTS OF LATER 6. DATE SHALL ALWAYS GOVERN.
- THE CONTRACTOR SHALL SECTION OFF THE CONSTRUCTION AREA SUCH THAT DUST IS KEPT TO A MINIMUM AND THE AREA OF WORK IS SECURED FROM UNAUTHORIZED ACCESS. THE CONTRACTOR IS TO KEEP THE SITE IN AN OCCUPIABLE AND OPERATIONAL STATE OF CLEANLINESS. OPERATIONAL SYSTEMS INCLUDE BUT ARE NOT LIMITED TO FIRE DETECTION & NOTIFICATION, HVAC AND ELECTRICAL SYSTEMS. IN THE EVENT SERVICE DISRUPTION AFFECTS OTHER TENANCIES, NOTICE OF SUCH SHALL BE PROVIDED BY THE CONTRACTOR AT LEAST 48 HOURS IN ADVANCE.
- THE SITE IS TO BE MAINTAINED THROUGHOUT THE DURATION OF THE CONTRACT, AND DEBRIS AND WASTE SHOULD NOT BE ALLOWED TO ACCUMULATE AND SHOULD BE REMOVED AT THE END OF EACH WORKING DAY AND LAWFULLY DISPOSED OF.
- 9. DRAWINGS ARE NOT TO BE SCALED
- 10. THE CONTRACTOR SHOULD TAKE NECESSARY PRECAUTIONS TO ADEQUATELY PROTECT THE SITE, THE WORKS, AND EXISTING PROPERTY. ALL DISTURBED WORK SHALL BE MADE GOOD TO MATCH EXISTING WORK OR AS DIRECTED BY THE PROJECT MANAGER.
- 11. ENSURE ALL EXISTING SURFACES IN THE GROUND FLOOR LOBBY AND ELEVATOR ARE WELL PROTECTED DURING CONSTRUCTION. ANY DAMAGE CAUSED TO EXISTING CONSTRUCTION WILL BE PATCHED AND MADE NEW AT THE CONTRACTOR'S EXPENSE.
- 12. THE CONTRACTOR IN CARRYING OUT THE WORK MUST ABIDE BY THE SAFETY AND HEALTH ACT (1982, AMENDMENTS OF ALL OCCUPATIONAL SAFETY & HEALTH) ENSURING THAT THE NECESSARY PRECAUTIONS ARE TAKEN TO ENSURE THE SAFETY AND HEALTH OF CONTRACT WORKERS, SITE VISITORS AND ALL PERSONNEL INVOLVED IN THE PROJECT OR ATTENDING THE PREMISES WHERE THE WORK IS BEING COMPLETED, INCLUDING KEEPING NOISE AND DIRT TO A MINIMUM.
- 13. THE CONTRACTOR IS RESPONSIBLE FOR LEAVING THE SITE SECURE EACH DAY THAT WORK IS BEING PERFORMED.
- 14. PROVIDE SAMPLES AND SUBMITTALS FOR ITEMS INCLUDING BUT NOT LIMITED TO DOOR HARDWARE, ACCESSORIES, FITTINGS & EQUIPMENT. PROVIDE SHOP DRAWINGS FOR ALL MILLWORK ITEMS
- 15. CUTTING AND PATCHING -ALL CUTTING AND PATCHING REQUIRED TO THE EXISTING BUILDING STRUCTURE FOR WORK SHALL BE INCLUDED UNDER THIS CONTRACT AND BE ACCEPTABLE TO THE ARCHITECT/OWNER. -WHERE CONDUITS PASS THROUGH FIRE RATED WALLS OR FLOORS, PROVIDE FIRE STOPPING MATERIAL LISTED WITH, AND BEAR LABEL OF CSA AND ULC. AND MAINTAIN SAME FIRE
- RATING OF BUILDING COMPONENT PENETRATION. 16. ALL INTERIOR FURNITURE FITTINGS AND EQUIPMENT TO BE COORDINATED WITH COMMERCIAL INTERIOR GROUPS (CIG) 'F' SERIES DRAWINGS (NOTED FOR REFERENCE ONLY)
- 17. ALL WINDOW INSTALLATION COORDINATION/ATTENDANCE MATTERS TO BE REFERRED TO THE PROJECT MANAGER FOR THE BERMUDA GOVERNMENT.
- 18. ALL PENETRATIONS (EXISTING & NEW) THROUGH FIRE RATED ASSEMBLIES INCLUDING BUT NOT LIMITED TO WALLS, SLABS AND CEILINGS SHOULD BE FIRE RATED PER CODE REQUIREMENTS.

SCOPE OF WORK NOTES:

- CONSTRUCTION.
- 2. CONDITION OF STRUCTURE: THE OWNER ASSUMES NO RESPONSIBILITY FOR THE CONDITION OF ITEMS OR STRUCTURES TO BE DEMOLISHED.
- 3. CONTRACTOR SHALL VERIFY ALL EXISTING CONDITIONS BEFORE STARTING ANY DEMOLITION OR CONSTRUCTION WORK.
- **TEMPORARY SIGNAGE:** DURING DEMOLITION OR ALTERATION 4. WORK IN BUILDINGS USED BY THE GENERAL PUBLIC AND STAFF, THE CONTRACTOR SHALL PROVIDE SIGNS DIRECTING BUILDING USERS TO NECESSARY SERVICES OF THE FACILITY, IN ADDITION TO SIGNS APOLOGIZING FROM DISRUPTION.
- 5. **PROTECTION:** THE CONTRACTOR SHALL PROVIDE TEMPORARY BARRICADES AND OTHER FORMS OF PROTECTION AS REQUIRED TO PROTECT THE OWNER'S PERSONNEL AND THE GENERAL PUBLIC FROM INJURY DUE TO SELECTIVE DEMOLITION WORK.
- 6.

WORK TO REMAIN.

LOCKS IF REQUIRED.

IMPACT TOOLS.

SITE.

SITE.

1. LOCATION: THE LOCATION OF SELECTIVE DEMOLITION TO THE BUILDING STRUCTURE WILL NORMALLY BE INDICATED ON THE DRAWINGS AS REQUIRED TO ACCOMMODATE NEW

- WHERE APPLICABLE, THE CONTRACTOR SHALL PROVIDE PROTECTIVE MEASURES TO PROVIDE FREE AND SAFE PASSAGE OF THE OWNER'S PERSONNEL AND THE GENERAL PUBLIC TO AND FROM OCCUPIED AREAS OF THE BUILDING.
- 7. WHERE NECESSARY, THE CONTRACTOR SHALL PROVIDE INTERIOR AND EXTERIOR SHORING, BRACING OR SUPPORT TO PREVENT MOVEMENT, SETTLEMENT, OR COLLAPSE OF THE STRUCTURE OR ELEMENT TO BE DEMOLISHED, AND ADJACENT FACILITIES OR
- 8. THE CONTRACTOR SHALL PROTECT FROM DAMAGE ANY EXISTING FINISH WORK THAT IS TO REMAIN AND BECOMES EXPOSED DURING DEMOLITION OPERATIONS, INCLUDING PROTECTING FLOORS WITH SUITABLE COVERINGS WHEN NECESSARY.
- 9. THE CONTRACTOR SHALL CONSTRUCT TEMPORARY DUST-PROOF PARTITIONS WHERE REQUIRED TO SEPARATE AREAS WHERE NOISY OR EXTENSIVE DIRT OR DUST OPERATION ARE PERFORMED, AND EQUIP PARTITIONS WITH DUST-PROOF DOORS AND SECURITY
- 10. THE CONTRACTOR SHALL PROVIDE TEMPORARY WEATHER PROTECTION BETWEEN DEMOLITION AND REMOVAL OF EXISTING CONSTRUCTION ON THE EXTERIOR SURFACES, AND THE INSTALLATION NEW CONSTRUCTION, TO ENSURE THAT NO WATER LEAKAGE OR DAMAGE OCCURS TO THE STRUCTURE AND INTERIOR AREAS OF THE EXISTING BUILDING.
- 11. THE CONTRACTOR SHALL MAKE PROVISION FOR THE CONTINUITY OF UTILITY SERVICES TO OCCUPIED AREAS OF THE SITE AND SHALL PERMANENTLY OR TEMPORARILY CAP OFF OR RELOCATE UTILITY SERVICE LINES AS REQUIRED.
- 12. CONCRETE AND MASONRY: CONCRETE AND MASONRY SHALL BE DEMOLISHED IN SMALL SECTIONS, CUT AT JUNCTIONS WITH CONSTRUCTION REMAIN, USING A POWER-DRIVEN MASONRY SAW OR HAND TOOLS WHERE POSSIBLE AND NOT POWER-DRIVEN
- 13. DEBRIS SHOULD BE PROMPTLY REMOVED TO AVOID IMPOSING EXCESSIVE LOADS ON SUPPORTING WALLS, FLOORS AND FRAMING, AND TO AVOID BLOCKING EGRESS TOO & FROM THE
- **14. SERVICES:** IF UNEXPECTED MECHANICAL, ELECTRICAL OR STRUCTURAL ELEMENTS ARE ENCOUNTERED, THE CONTRACTOR SHALL SUBMIT DETAILS OF SUCH TO THE ARCHITECT.
- 15. ASBESTOS AND OTHER HAZARDOUS MATERIALS: IF HAZARDOUS MATERIALS ARE ENCOUNTERED DURING DEMOLITION OR OTHER OPERATIONS, THE CONTRACTOR SHALL CEASE WORK IN THE AFFECTED AREA AND SUBMIT A REPORT TO THE ARCHITECT: ANY WORK IN SUCH AN AREA SHALL COMPLY WITH
- APPLICABLEREGULATIONS CONCERNING REMOVAL, HANDLING, PROTECTION AGAINST EXPOSURE AND ENVIRONMENTAL POLLUTION, AND DISPOSAL.
- 16. BURNING OF ANY REMOVED MATERIALS IS NOT PERMITTED ON THE
- **17. PARKING:** THE GENERAL CONTRACTOR IS TO COORDINATE WITH THE CORPORATION OF HAMILTON IN SECURING CURB SIDE PARKING FOR LOADING AND UNLOADING OF BUILDING MATERIAL

GENERAL RCP NOTES:

- CONTRACTOR TO REVIEW EXISTING CEILING SITE 1. CONDITIONS PRIOR TO COMMENCEMENT OF CONSTRUCTION. REPORT ANY INTERFERENCE WITH DUCTS, BEAMS, PIPES ETC IMMEDIATELY TO DESIGNER.
- 2 ALL MECHANICAL AND ELECTRICAL WORKS TO COMPLY WITH BERMUDA BUILDING CODE REQUIREMENTS AND ALL AUTHORITIES HAVING JURISDICTION. ANY CHANGES TO BE REVIEWED WITH DESIGNER.
- MECHANICAL CONTRACTOR RESPONSIBLE FOR 3. ALL LABOUR AND MATERIALS TO COMPLETE THE NECESSARY HVAC ALTERATIONS.
- WHERE REQUIRED PROVIDE FIRE DAMPERS AT ALL DUCTS PENETRATING FIRE SEPARATION.
- ALL SWITCHES AND COVER PLATES TO MATCH EXISTING, MULTIPLE SWITCHES TO BE GANGED.
- ALL EXISTING, NEW AND RELOCATED EMERGENCY EXIT SIGNS TO BE CONNECTED TO BASE BUILDING EMERGENCY SYSTEM.
- 7. PROTECT EXISTING CEILING SYSTEM AND LIGHT FIXTURE DURING CONSTRUCTION. CLEAN ALL LIGHT FIXTURES UPON COMPLETION.
- NOMINATED MECHANICAL AND ELECTRICAL SUB CONTRACTORS TO REPLACE ANY DAMAGED TILES WITH NEW TILES AND RELOCATE EXISTING TILES IN AREAS AFFECTED BY THEIR WORK.
- REUSE EXISTING LIGHT SWITCHES WHERE POSSIBLE, ENSURE SUFFICIENT SWITCHES ARE PROVIDED IN OPEN OFFICE AREAS. PROVIDE SEPARATE LIGHT SWITCH FOR NEW DOWNLIGHTS AND WALL SCONCES.
- 10. THESE DRAWINGS ARE TO BE READ IN CONJUNCTION WITH THE STRUCTURAL MECHANICAL, ELECTRICAL AND ARCHITECTURAL DRAWING.
- 11. ALL NEW DRYWALL CEILINGS (UNLESS OTHERWISE SPECIFIED) TO BE 1/2" THICK USG DRYWALL FIXED TO GALVANIZED STEEL FRAMING. TAPE, FILL AND SAND READY FOR PAINT FINISH.
- 12. ANY PROPOSED CHANGES AND/OR MODIFICATIONS DUE TO FIELD CONDITIONS MUST RECEIVE APPROVAL FROM DESIGNER AND MEP CONSULTANTS.
- 13. MECHANICAL SUBCONTRACTOR TO ARRANGE FOR AN INSPECTION AND BALANCING REPORT AFTER PROJECT COMPLETION. UPON COMPLETION, THE HVAC SYSTEM IS TO BE FULLY BALANCED TO THE SATISFACTION OF THE OWNER.
- 14. ELECTRICAL CONTRACTOR TO SUBMIT CUT SHEETS ON ALL FIXTURES FOR DESIGNER/ARCHITECT REVIEW.
- 15. ALL SWITCHES ON PARTITIONS TO BE MOUNTED VERTICALLY 8" FROM DOOR FRAME OR AS NOTED ON DRAWING.
- 16. DIMENSIONS ARE FROM THE FACE OF THE WALL TO CENTER OF THE FIXTURE (U.O.N.). RECESSED DOWNLIGHTS ARE TO BE INSTALLED IN CENTER OF CEILING TILE UNLESS DIMENSIONED OTHERWISE.
- 17. ALL FIRE DETECTORS AND DIFFUSERS MUST NOT BE WITHIN 3'-0" ON CENTRE OF EACH OTHER. CONTRACTOR TO COORDINATE W/FIRE ALARM TECHNICIAN.


GENERAL DEMOLITION NOTES:

- 1. FIELD VERIFY ALL DIMENSIONS AND CONDITIONS IN THE EVENT THAT DISCREPANCIES ARE NOTED BETWEEN SITE CONDITIONS AND THE PROJECT DOCUMENTS.
- 2. PROTECT EXISTING CONSTRUCTION AT PERIMETER WALLS, EXISTING FURRED COLUMNS AND AREAS ADJACENT TO DEMOLITION.
- 3. WHERE EXISTING CONSTRUCTION HAS BEEN REMOVED, PREP SUBSURFACES AND ADJACENT SURFACES AS REQ'D FOR NEW CONSTRUCTION.
- 4. SALVAGE (REMOVE & REUSE) EXISTING DOORS, FRAMES AND HARDWARE. SPARE DOORS AND HARDWARE TO BE TURNED OVER TO OWNER'S STOCK IF DESIRED.
- 5. REFER TO MEP DRAWINGS FOR DEMOLTION SCOPE OF PLUMBING FIXTURES, ELECTRICAL AND HVAC ITEMS.
- 6. EXISTING DUCTING TO BE ALTERED TO SUIT NEW LAYOUTS. (REFER TO MECHANICAL DRAWINGS)
- 7. CO-ORDINATE FOR DISCONNECT AND RELOCATION OF EXISTING WALL MOUNTED FIRE/ SECURITY/ ELECTRICAL PANELS AS REQUIRED. (REFER TO ELECTRICAL DRAWINGS)
- 8. ENSURE MINIMAL DISTURBANCE TO ANY OCCUPIED SPACE ADJACENT TO AREAS WHERE DEMOLITION OCCURS.
- 9. USE OF ANY SOLVENT STRIPPERS TO OCCUR AFTER HOURS FOLLOWING PROPER VENTILATION PROCEDURES.
- 10. REPAIR AND MAKE NEW ALL EXISTING SURFACES AFFECTED BY DEMOLITION WORK. FINISHES TO MATCH ADJACENT SURFACES U.N.O.
- 11. CONTRACTOR TO ENSURE GOVERNMENT ITO DATA SERVICE PROVIDERS HAVE ACCESS TO THE SITE FOR THE ENTIRE DURATION OF WORKS. ATTENDANCE TO BE INCLUDED IN CONTRACTORS BID PRICE.

ELECTRICAL/MECHANICAL/STRUCTURAL

1. ALL ARCHITECTURAL DRAWINGS TO BE REFERENCED IN CONJUNCTION WITH STRUCTURAL, ELECTRICAL, AND MECHANICAL DETAILS SUBMITTED BY THE DESIGN ENGINEER OF RECORD.

GENERAL DRAWING LEGEND

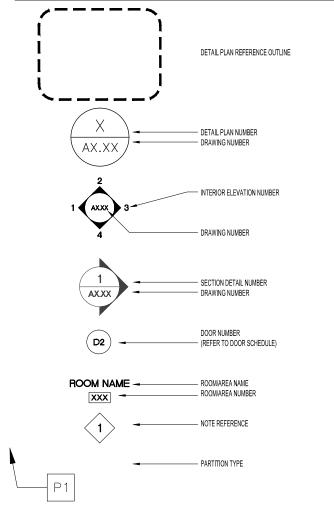

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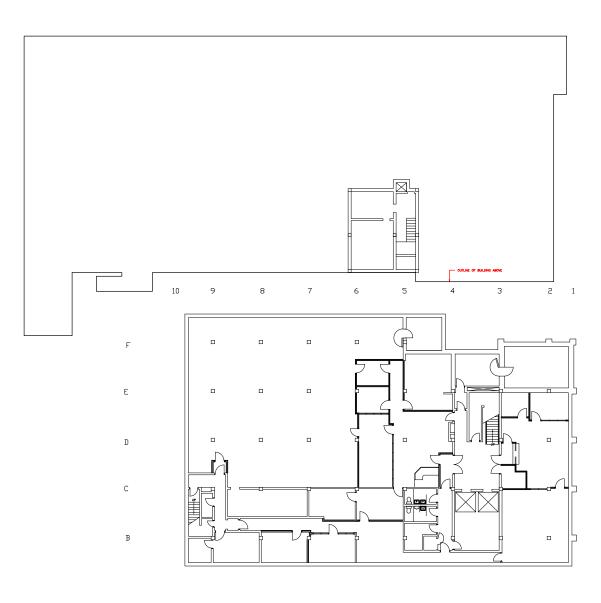
RELOCATION OF PARCEL POST PROCESSING FUNCTION'S


56 CHURCH STREET GROUND & BASEMENT LEVEL CITY OF HAMILTON BERMUDA


Sheet Title: **GENERAL NOTES**

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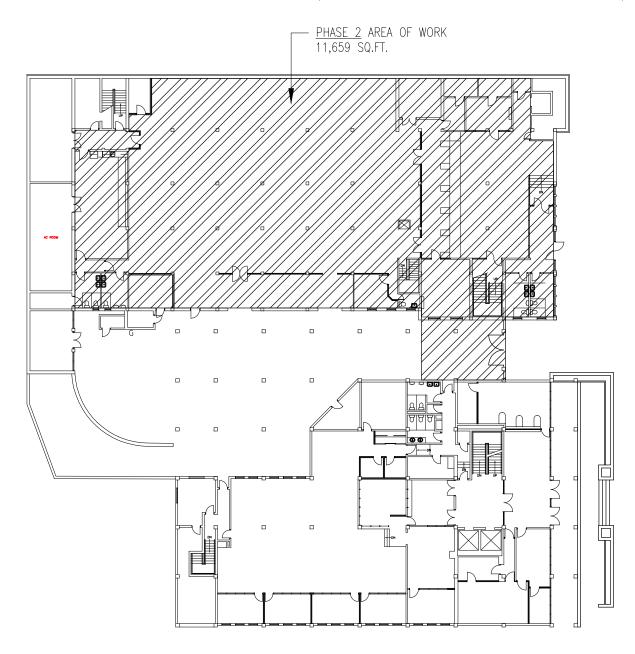





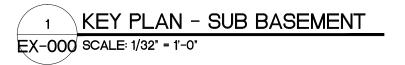



4 KEY PLAN - SECOND FLOOR EX-000 SCALE: 1/32" = 1'-0"

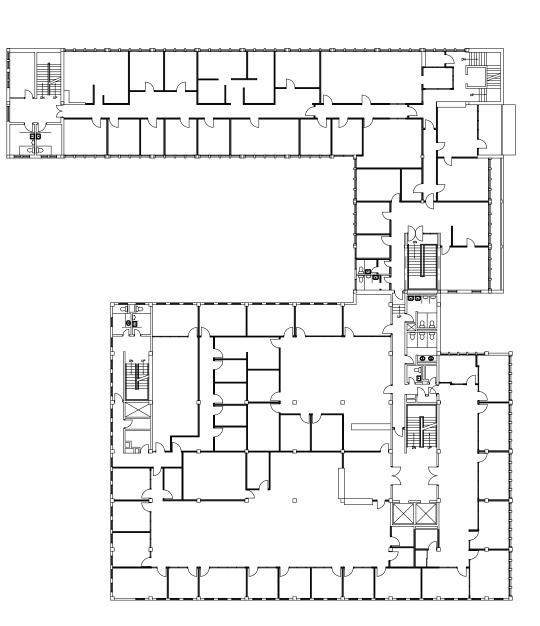
*NOTE: ALL MECHANICAL, ELECTRICAL, PLUMBING AND STRUCTURAL DESIGN SERVICES BY OTHERS (UNDER THE DIRECTION OF PUBLIC LANDS AND BUILDINGS)



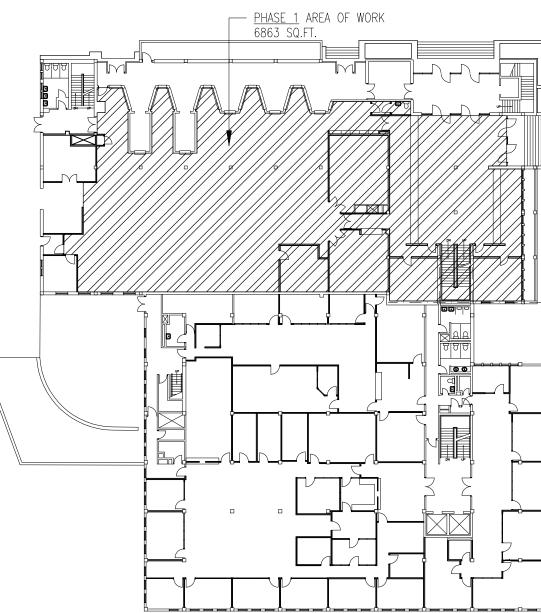

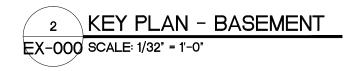

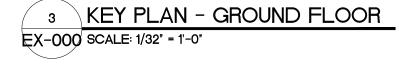

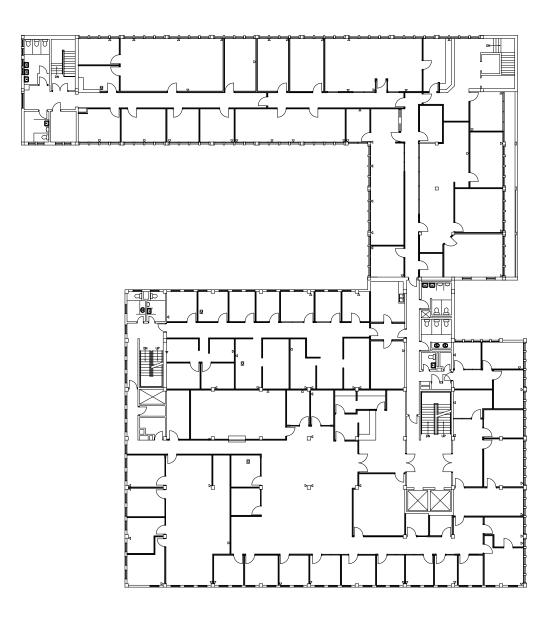

5 KEY PLAN - THIRD FLOOR EX-000 SCALE: 1/32" = 1'-0"

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Sheet Title: PHASING KEY PLAN

56 CHURCH STREET GROUND & BASEMENT LEVEL CITY OF HAMILTON BERMUDA

RELOCATION OF PARCEL POST PROCESSING FUNCTION'S

Project Title:

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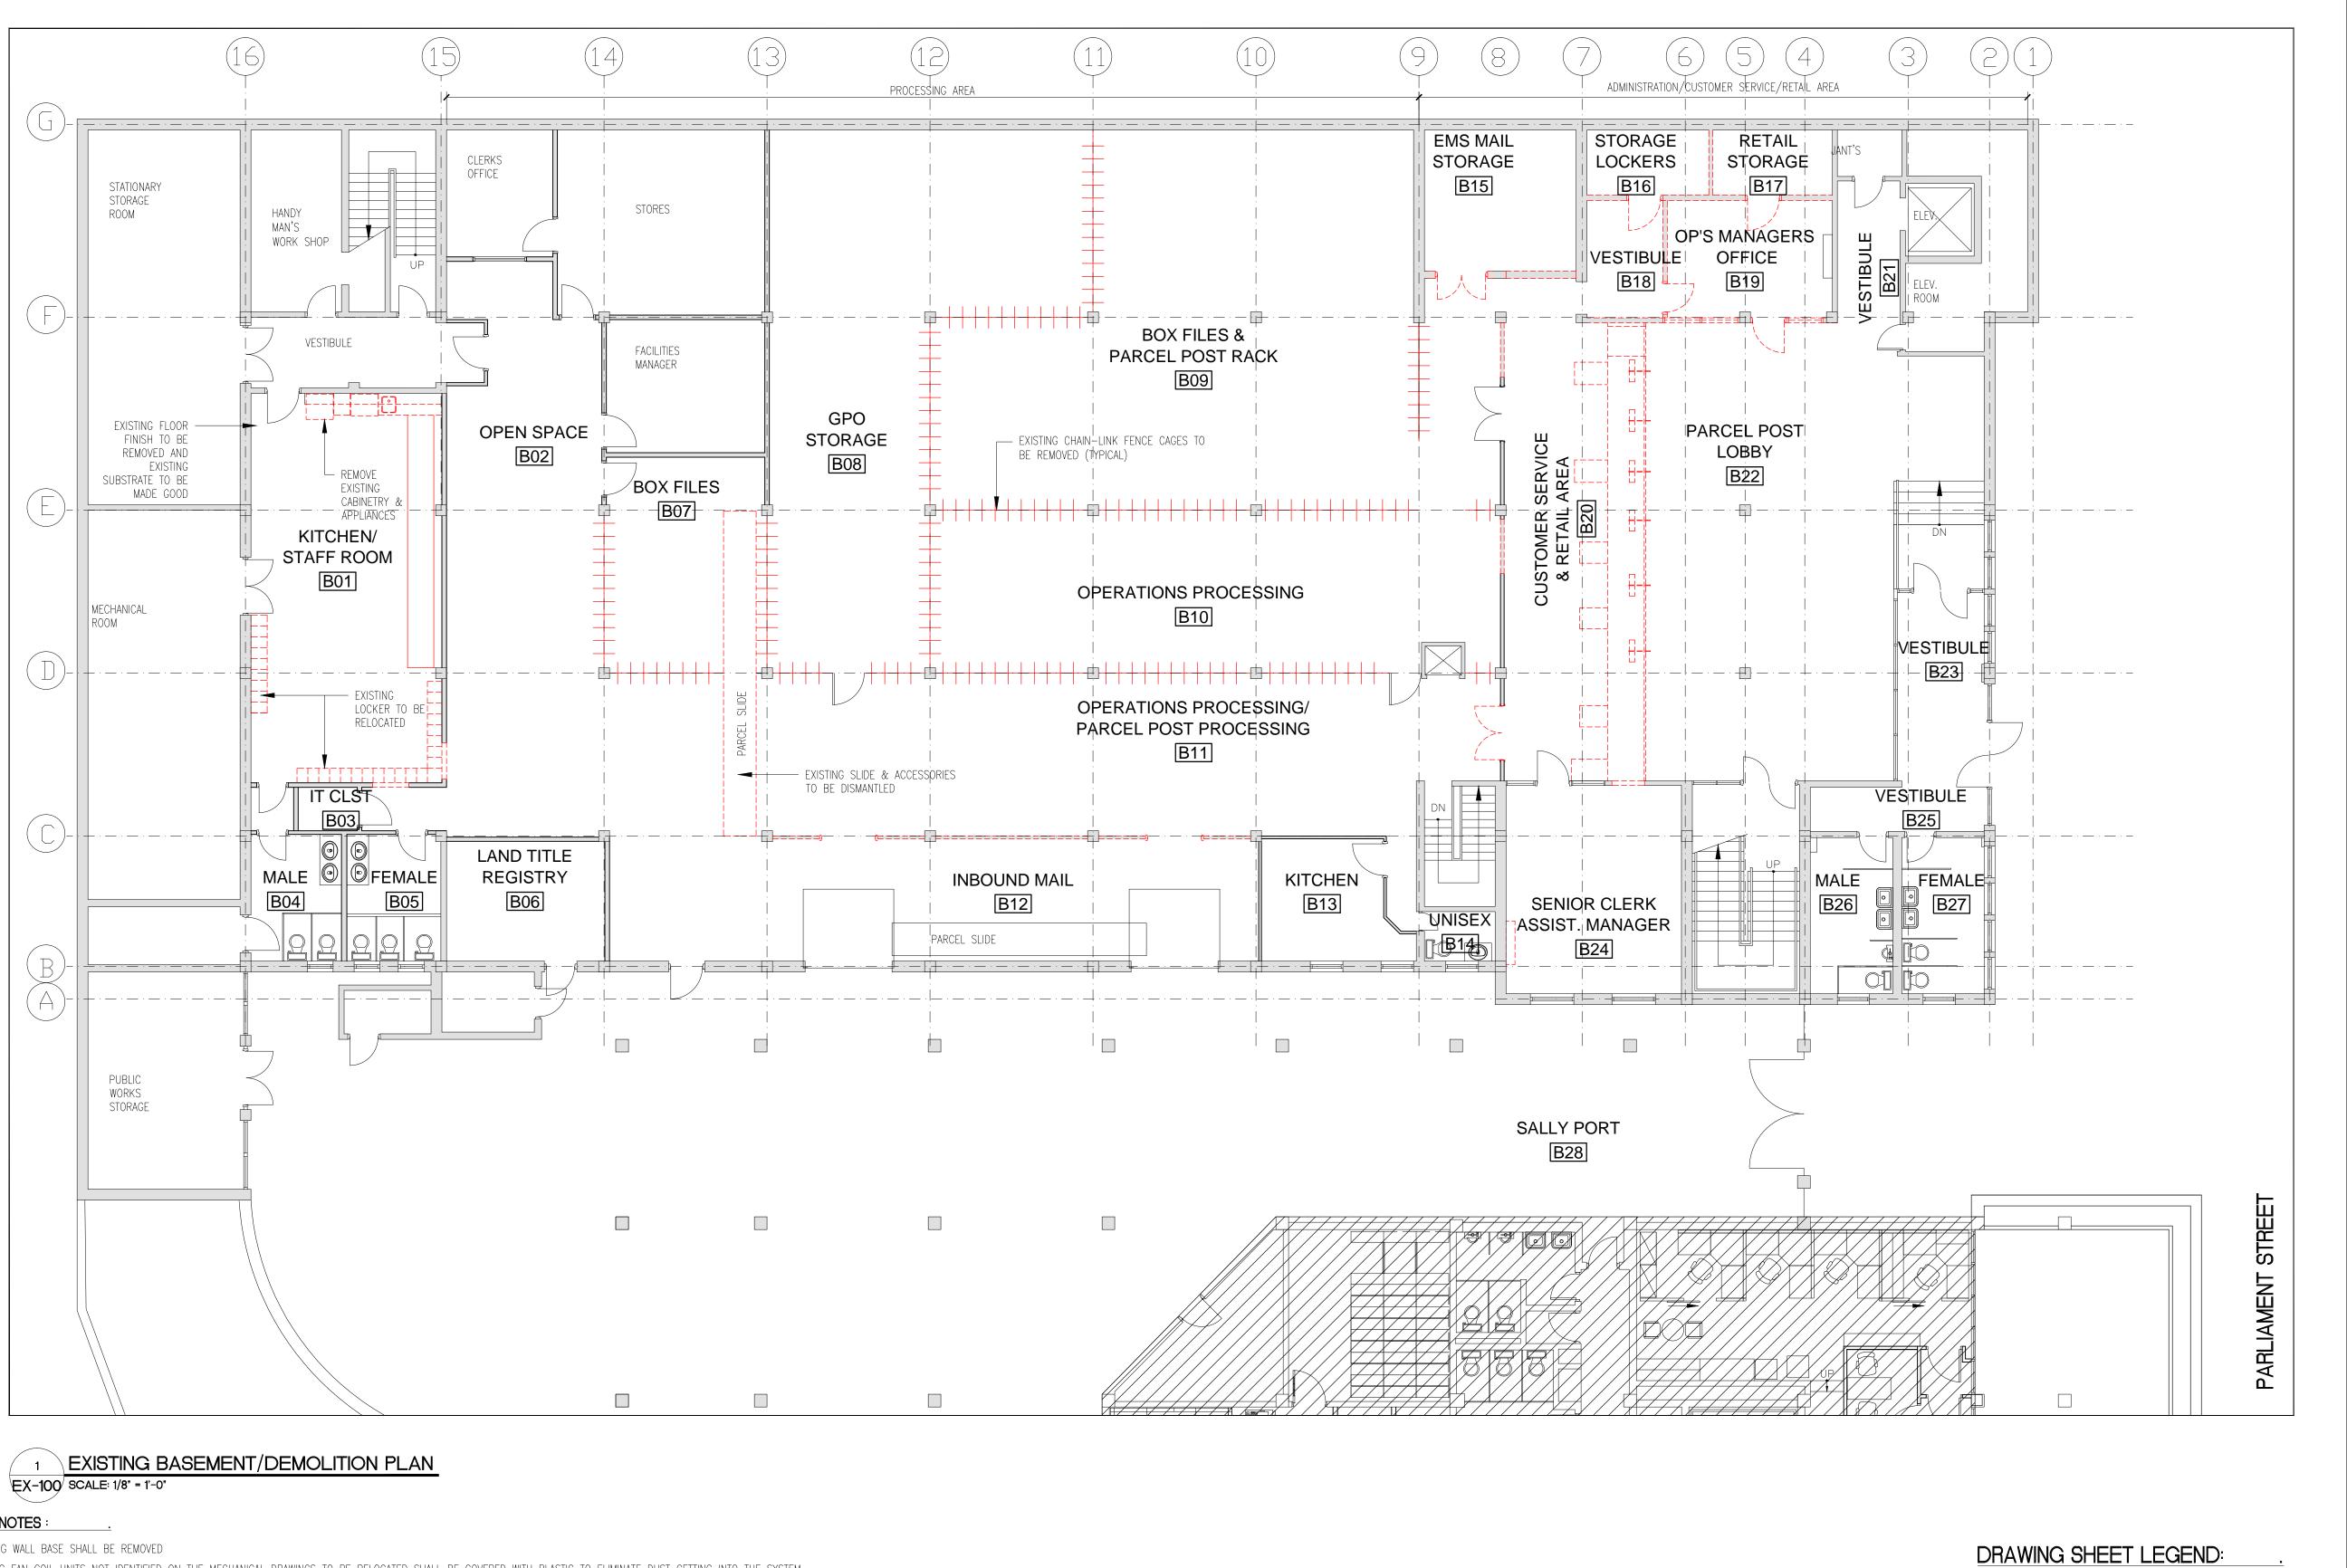
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DEMOLITION NOTES :

- 1. ANY EXISTING WALL BASE SHALL BE REMOVED
- 2. ALL EXISTING FAN COIL UNITS NOT IDENTIFIED ON THE MECHANICAL DRAWINGS TO BE RELOCATED SHALL BE COVERED WITH PLASTIC TO ELIMINATE DUST GETTING INTO THE SYSTEM.
- 3. ALL EXISTING CARPET & UNDERLAY TO BE REMOVED. THE SUB-SURFACE SHOULD BE CLEAN, DRY (FREE FROM SURFACE & SUB-SURFACE MOISTURE), SMOOTH, LEVEL AND FREE OF LOOSE OR OTHER MATERIAL AND CRACKS/CHIPS WHICH WILL AFFECT THE BOND. SLABS THAT ARE UNEVEN SHALL BE GROUND DOWN AND/OR BUILT UP OR FILLED WITH APPROVED LEVELING COMPOUND. AVOID DISTURBING EXISTING VINYL ASBESTOS TILES.
- 4. ALL EXISTING BULKHEADS, ACOUSTICAL CEILINGS AND ASSOCIATED M&E ARE TO BE REMOVED.
- 5. ALL EXISTING DOORS AND FRAMES AND HARDWARE ARE TO BE REMOVED AND HANDED OVER TO THE PROJECT MANAGER
- 6. REFER TO MECHANICAL & ELECTRICAL ENGINEERING DRAWINGS FOR ALL LOCATIONS OF EXISTING MECHANICAL & ELECTRICAL DEVICES TO BE REMOVED.
- 7. ALL SERVICES TO BE REMOVED ARE TO BE SAFELY CAPPED WITHIN THE WALL, FLOOR OR CEILING IN COMPLIANT WITH APPLICABLE CODES. REFER TO ENGINEERS DRAWINGS.

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RELOCATION OF PARCEL POST PROCESSING FUNCTION'S

56 CHURCH STREET GROUND & BASEMENT LEVEL CITY OF HAMILTON BERMUDA

Sheet Title: EXISTING **BASEMENT/DEMOLITION PLAN**

Revisions: ___


EXISTING BASE BUILDING

NEW STUD WALL PARTITION

SHADED AREA INDICATES NOT IN CONTRACT

DEMOLITION/REMOVAL



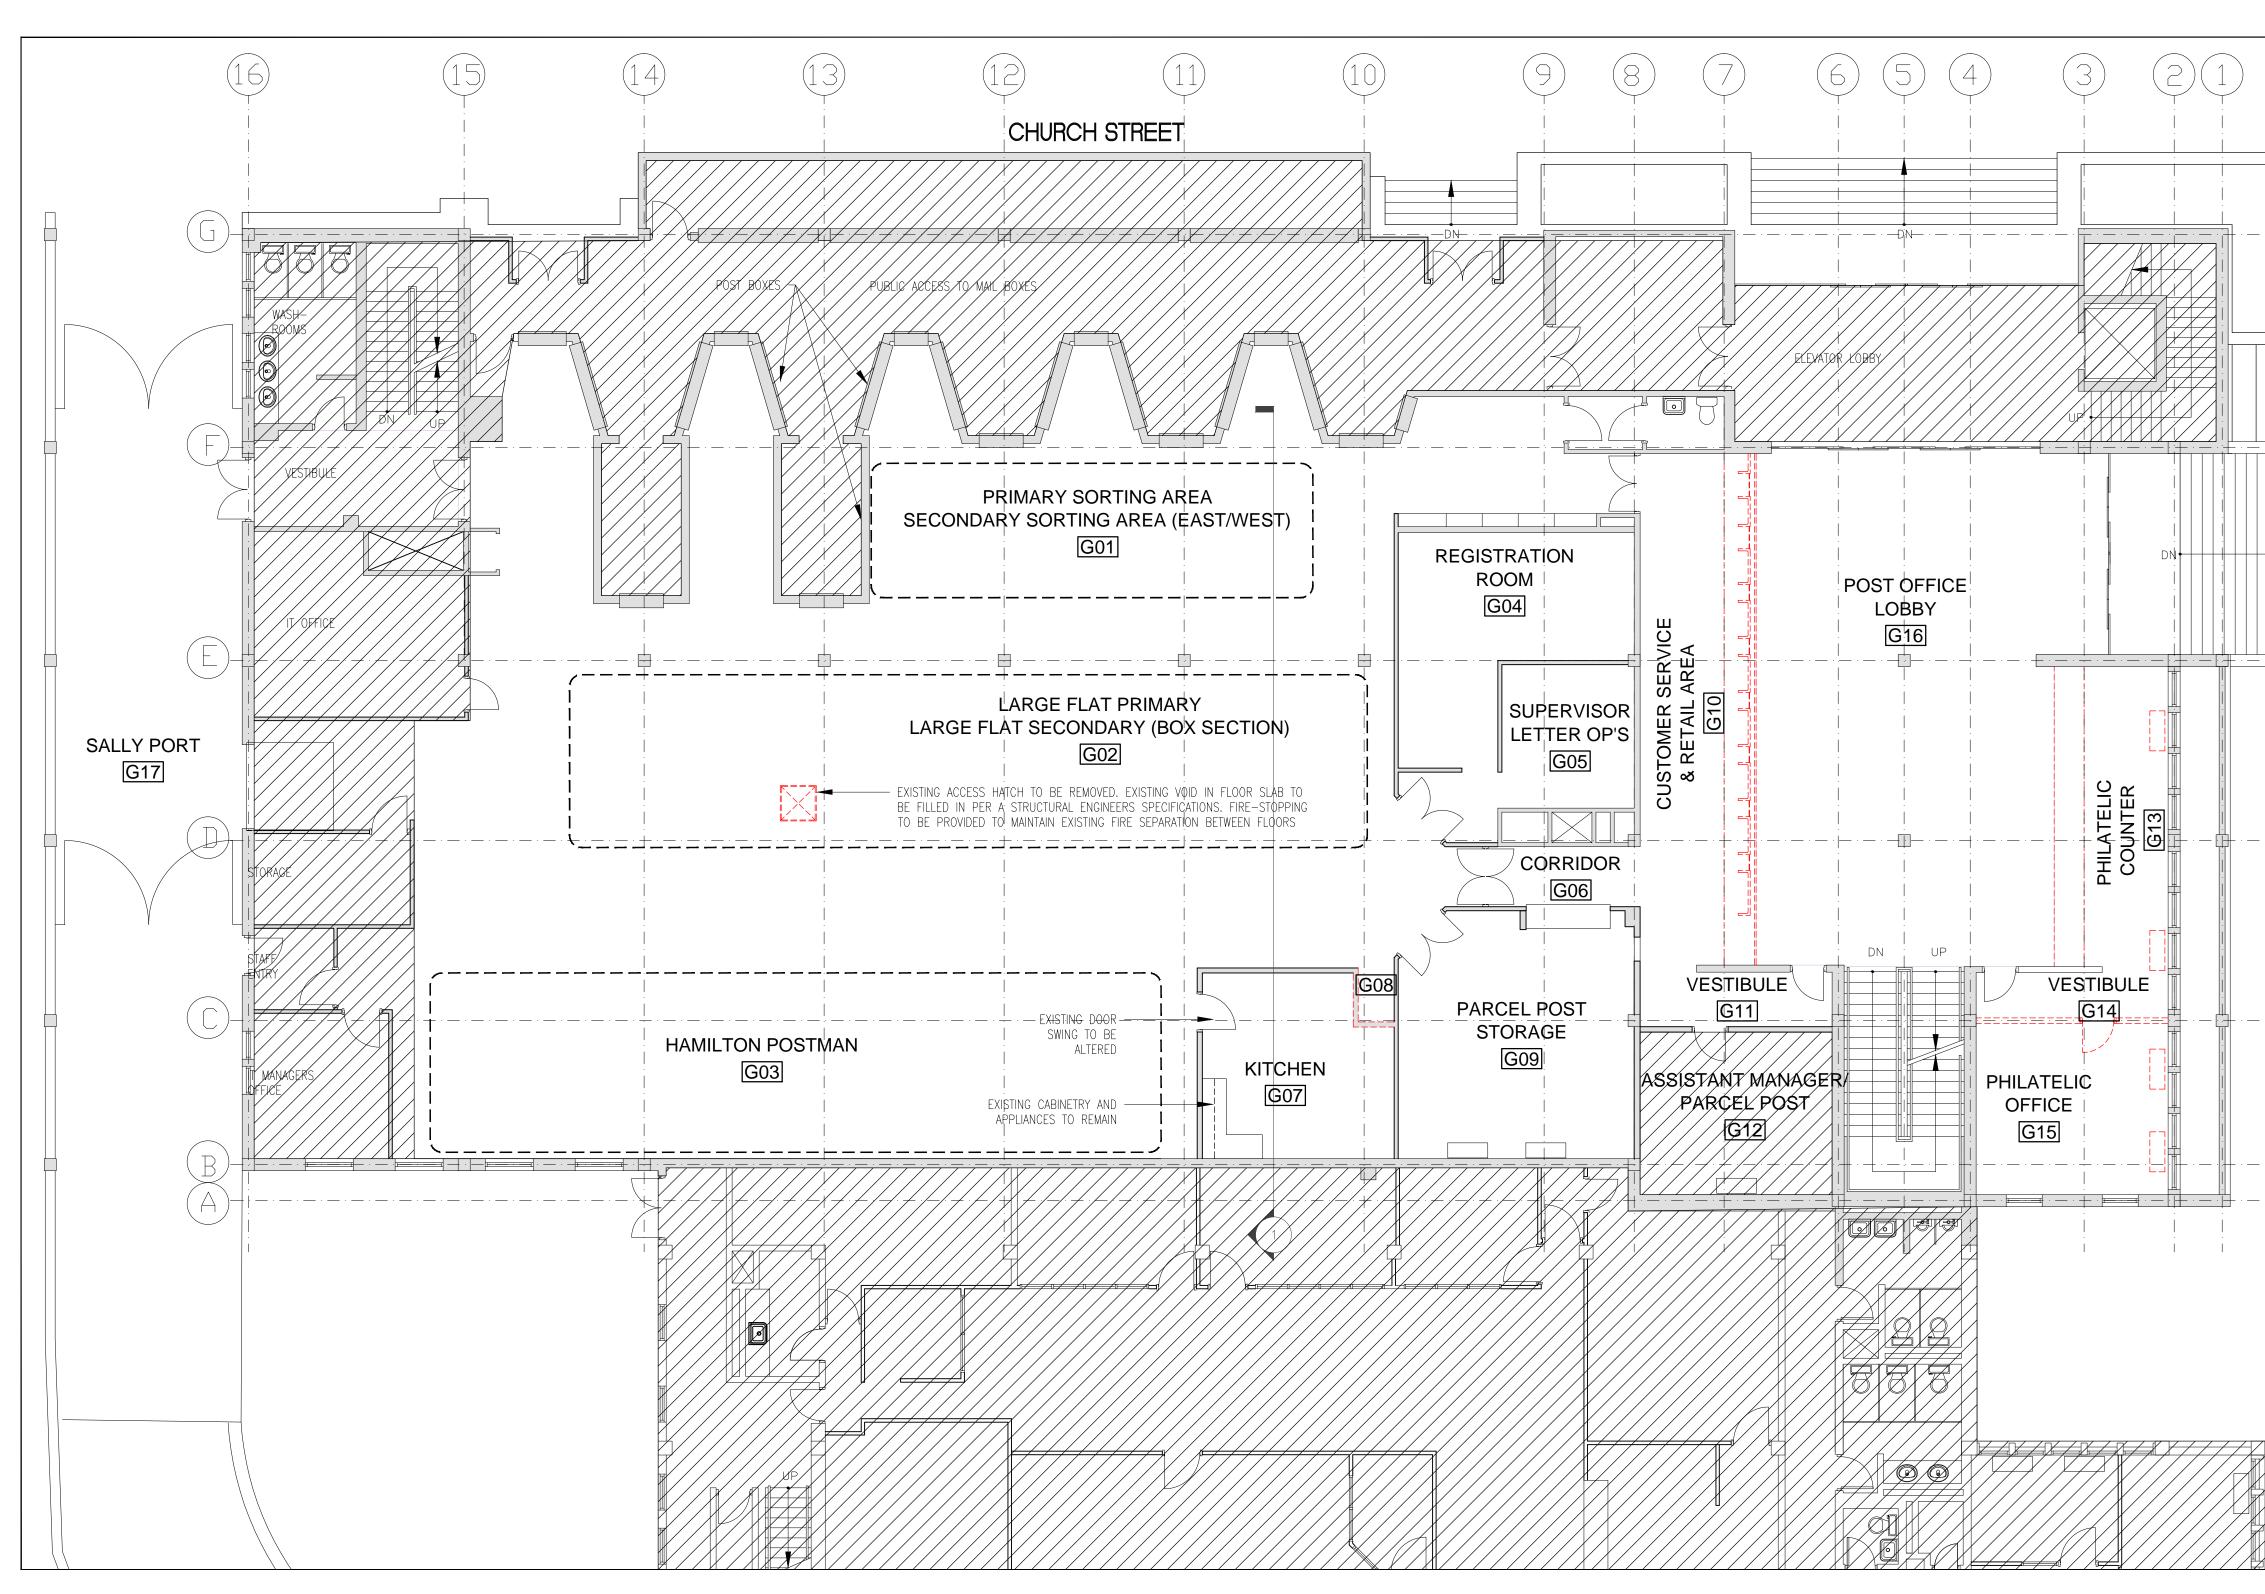


1 EXISTING GROUND FLR./DEMOLITION PLAN EX-101 SCALE: 1/8" = 1'-0"


DEMOLITION NOTES :

- 1. ANY EXISTING WALL BASE SHALL BE REMOVED
- 2. ALL EXISTING FAN COIL UNITS NOT IDENTIFIED ON THE MECHANICAL DRAWINGS TO BE RELOCATED SHALL BE COVERED WITH PLASTIC TO ELIMINATE DUST GETTING INTO THE SYSTEM.
- 3. ALL EXISTING CARPET & UNDERLAY TO BE REMOVED. THE SUB-SURFACE SHOULD BE CLEAN, DRY (FREE FROM SURFACE & SUB-SURFACE MOISTURE), SMOOTH, LEVEL AND FREE OF LOOSE OR OTHER MATERIAL AND CRACKS/CHIPS WHICH WILL AFFECT THE BOND. SLABS THAT ARE UNEVEN SHALL BE GROUND DOWN AND/OR BUILT UP OR FILLED WITH APPROVED LEVELING COMPOUND. AVOID DISTURBING EXISTING VINYL ASBESTOS TILES.
- 4. ALL EXISTING BULKHEADS, ACOUSTICAL CEILINGS AND ASSOCIATED M&E ARE TO BE REMOVED.
- 5. ALL EXISTING DOORS AND FRAMES AND HARDWARE ARE TO BE REMOVED AND HANDED OVER TO THE PROJECT MANAGER
- 6. REFER TO MECHANICAL & ELECTRICAL ENGINEERING DRAWINGS FOR ALL LOCATIONS OF EXISTING MECHANICAL & ELECTRICAL DEVICES TO BE REMOVED.
- 7. ALL SERVICES TO BE REMOVED ARE TO BE SAFELY CAPPED WITHIN THE WALL, FLOOR OR CEILING IN COMPLIANT WITH APPLICABLE CODES. REFER TO ENGINEERS DRAWINGS.

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DRAWING SHEET LEGE EXISTING BASE BUILDING EXISTING BASE BUILDING DEMOLITION/REMOVAL NEW STUD WALL PARTITION	<u>ND: .</u>	EX	t Title: ISTING GROUND LEV OOR/DEMOLITION PI	
SHADED AREA INDICATES NOT	N CONTRACT	Revi	isions: Sheet Number:	C-101

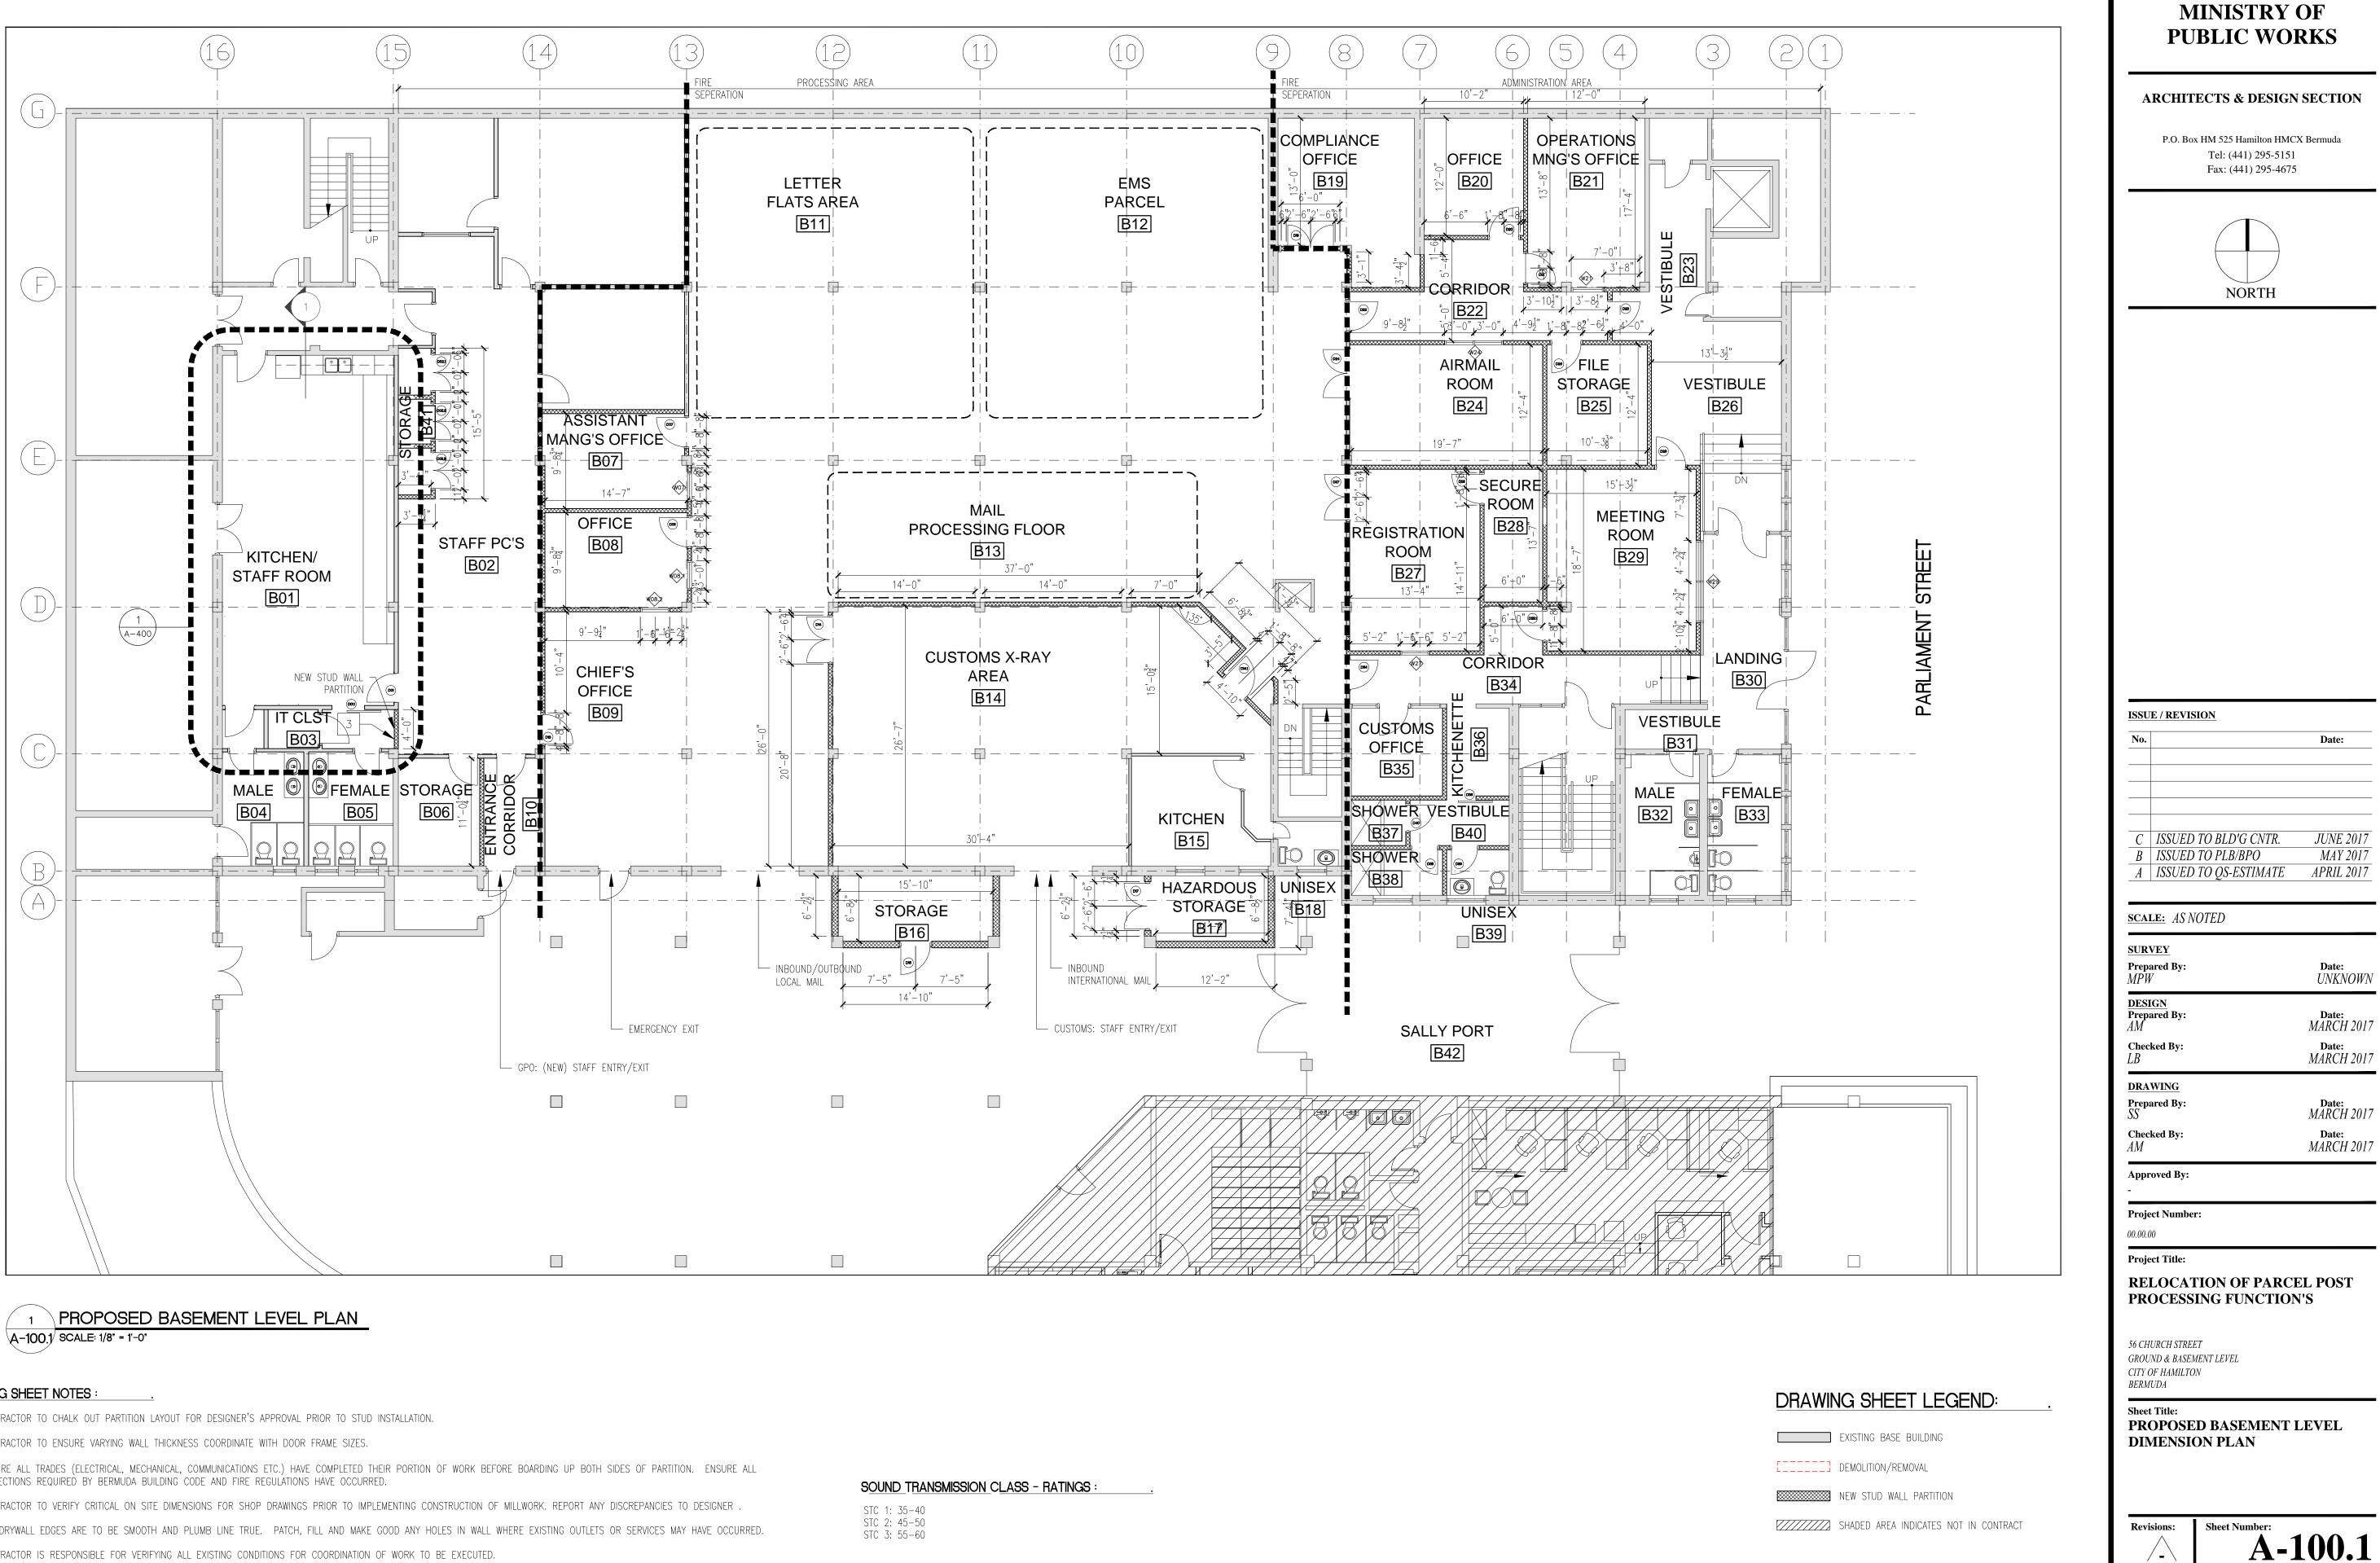

- 1. CONTRACTOR TO CHALK OUT PARTITION LAYOUT FOR DESIGNER'S APPROVAL PRIOR TO STUD INSTALLATION.
- 2. CONTRACTOR TO ENSURE VARYING WALL THICKNESS COORDINATE WITH DOOR FRAME SIZES.
- 3. ENSURE ALL TRADES (ELECTRICAL, MECHANICAL, COMMUNICATIONS ETC.) HAVE COMPLETED THEIR PORTION OF WORK BEFORE BOARDING UP BOTH SIDES OF PARTITION. ENSURE ALL INSPECTIONS REQUIRED BY BERMUDA BUILDING CODE AND FIRE REGULATIONS HAVE OCCURRED.
- 4. CONTRACTOR TO VERIFY CRITICAL ON SITE DIMENSIONS FOR SHOP DRAWINGS PRIOR TO IMPLEMENTING CONSTRUCTION OF MILLWORK. REPORT ANY DISCREPANCIES TO DESIGNER .
- 5. ALL DRYWALL EDGES ARE TO BE SMOOTH AND PLUMB LINE TRUE. PATCH, FILL AND MAKE GOOD ANY HOLES IN WALL WHERE EXISTING OUTLETS OR SERVICES MAY HAVE OCCURRED.
- 6. CONTRACTOR IS RESPONSIBLE FOR VERIFYING ALL EXISTING CONDITIONS FOR COORDINATION OF WORK TO BE EXECUTED.

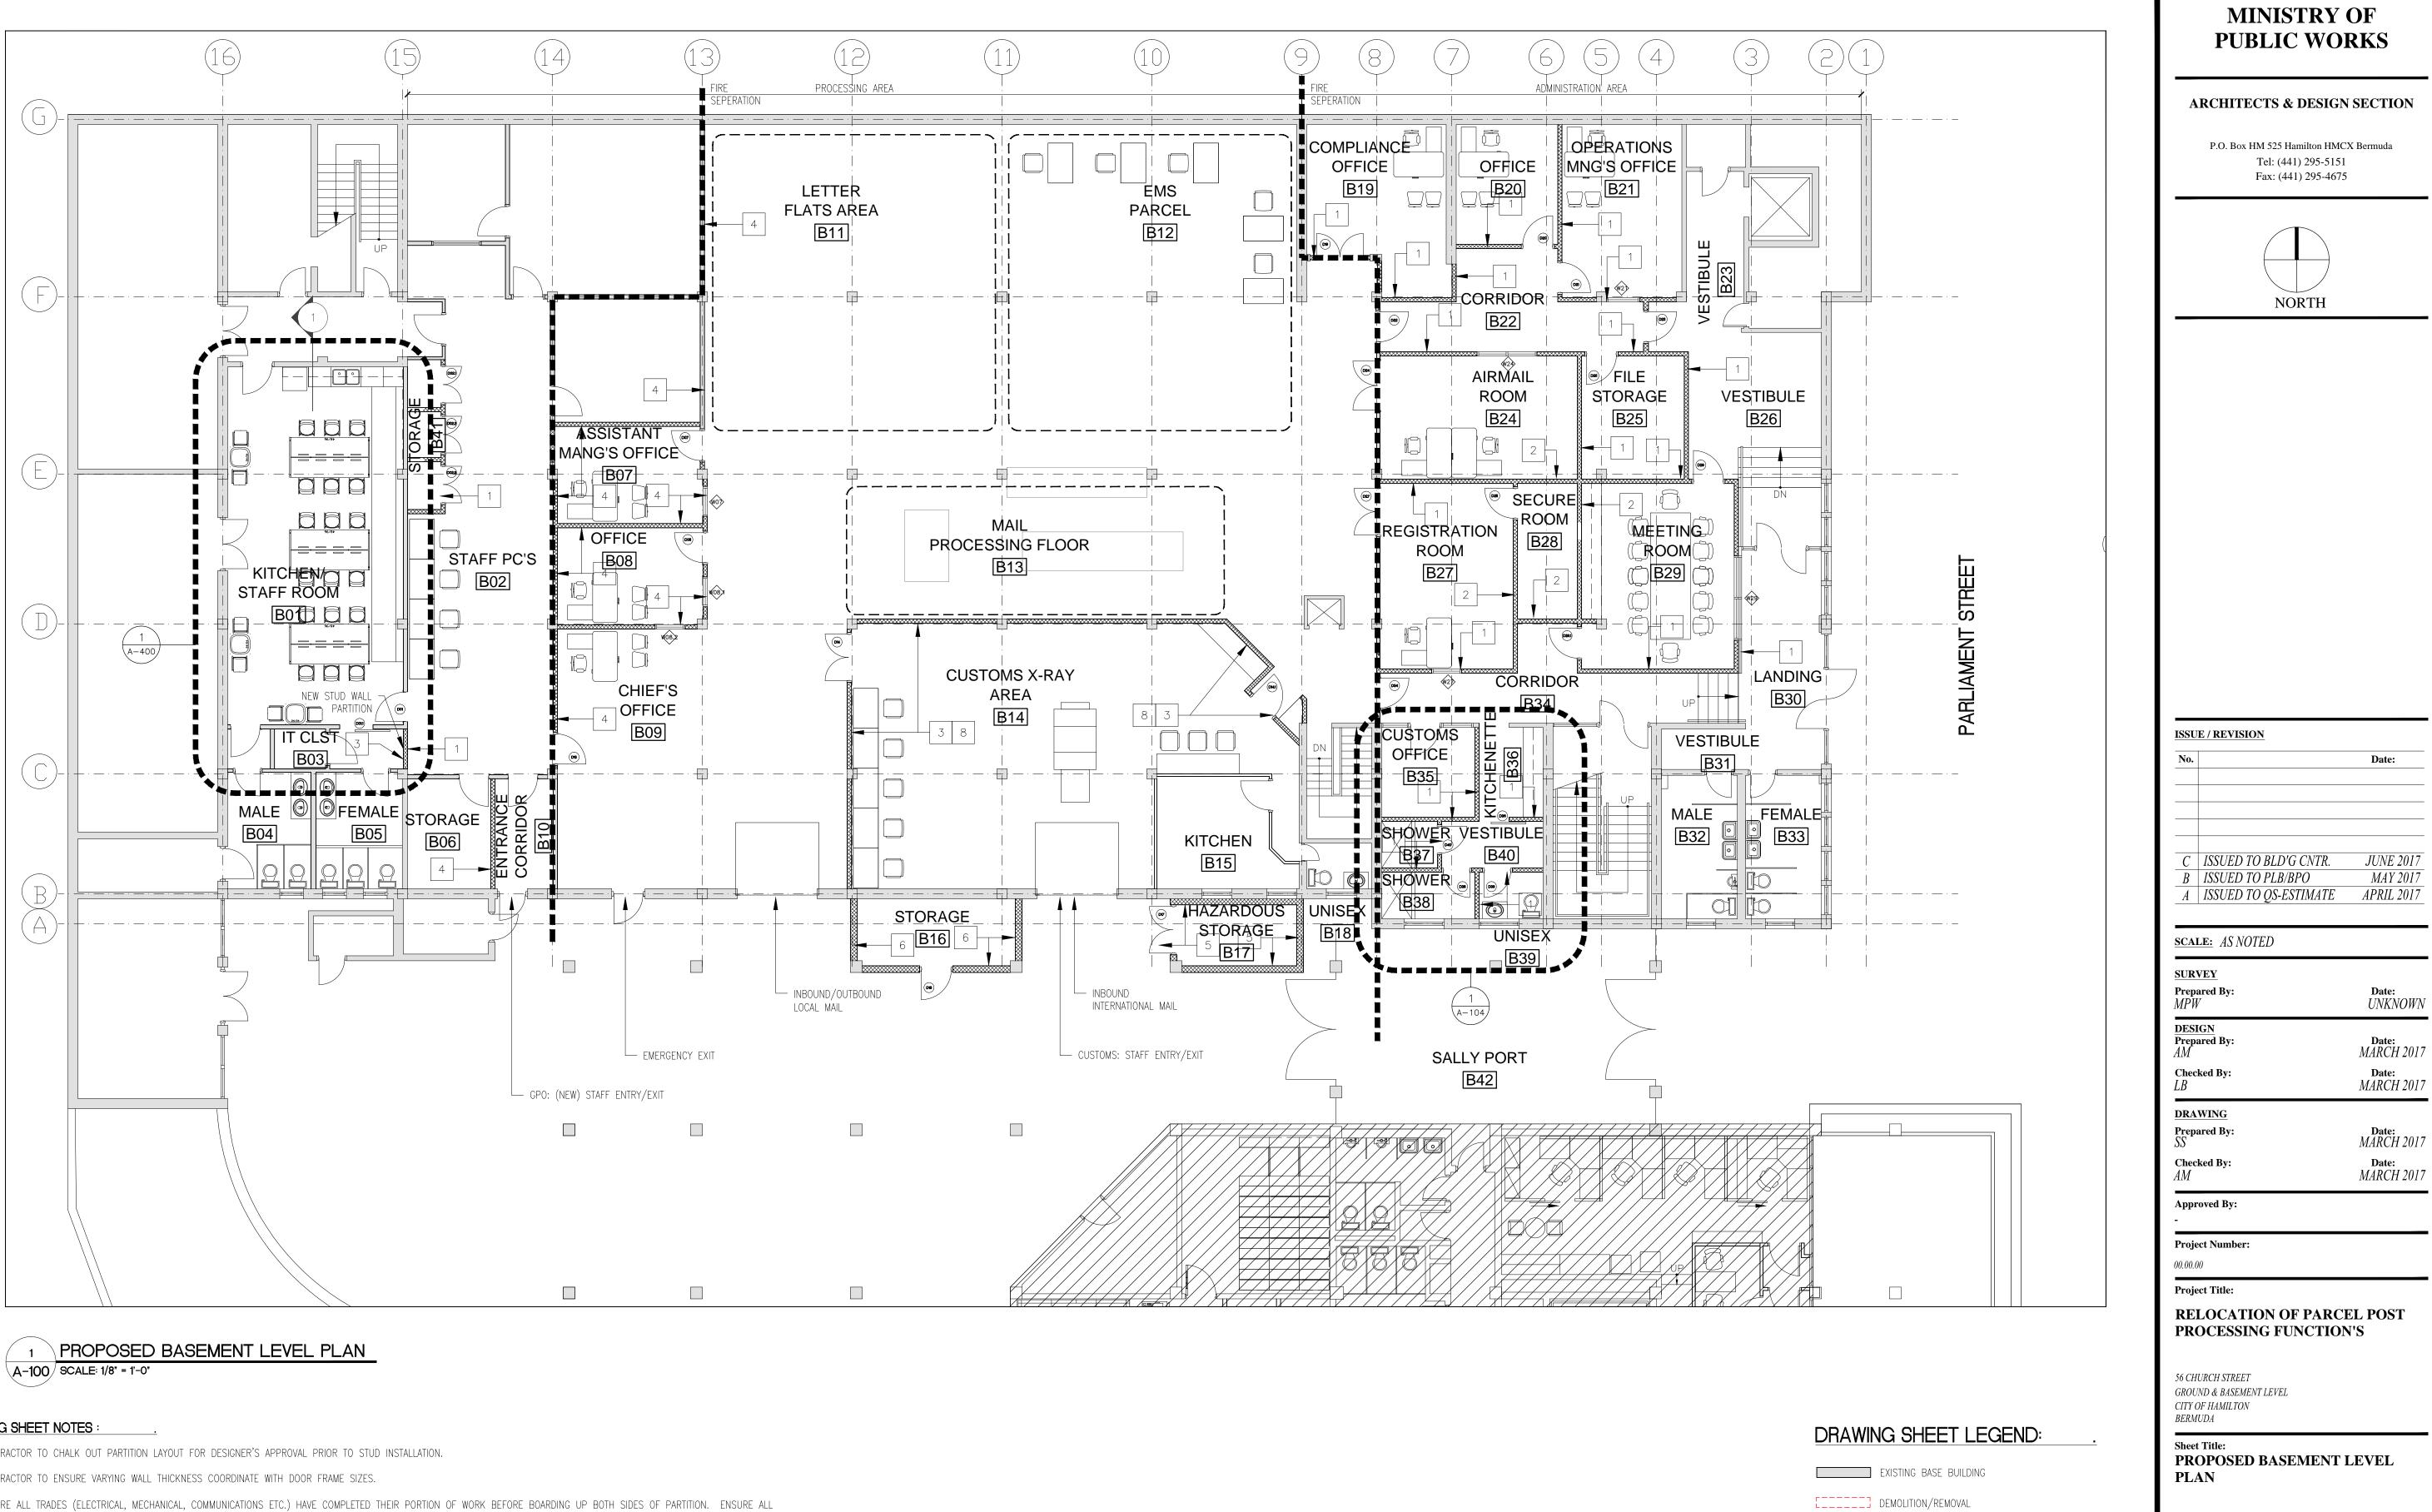

- 1. CONTRACTOR TO CHALK OUT PARTITION LAYOUT FOR DESIGNER'S APPROVAL PRIOR TO STUD INSTALLATION.
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Revisions:




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NEW STUD WALL PARTITION SHADED AREA INDICATES NOT IN CONTRACT



PROPOSED GROUND LEVEL DIMENSION PLAN 1 A-101.1 SCALE: 1/8" = 1'-0"

DRAWING SHEET NOTES :

1. CONTRACTOR TO CHALK OUT PARTITION LAYOUT FOR DESIGNER'S APPROVAL PRIOR TO STUD INSTALLATION.
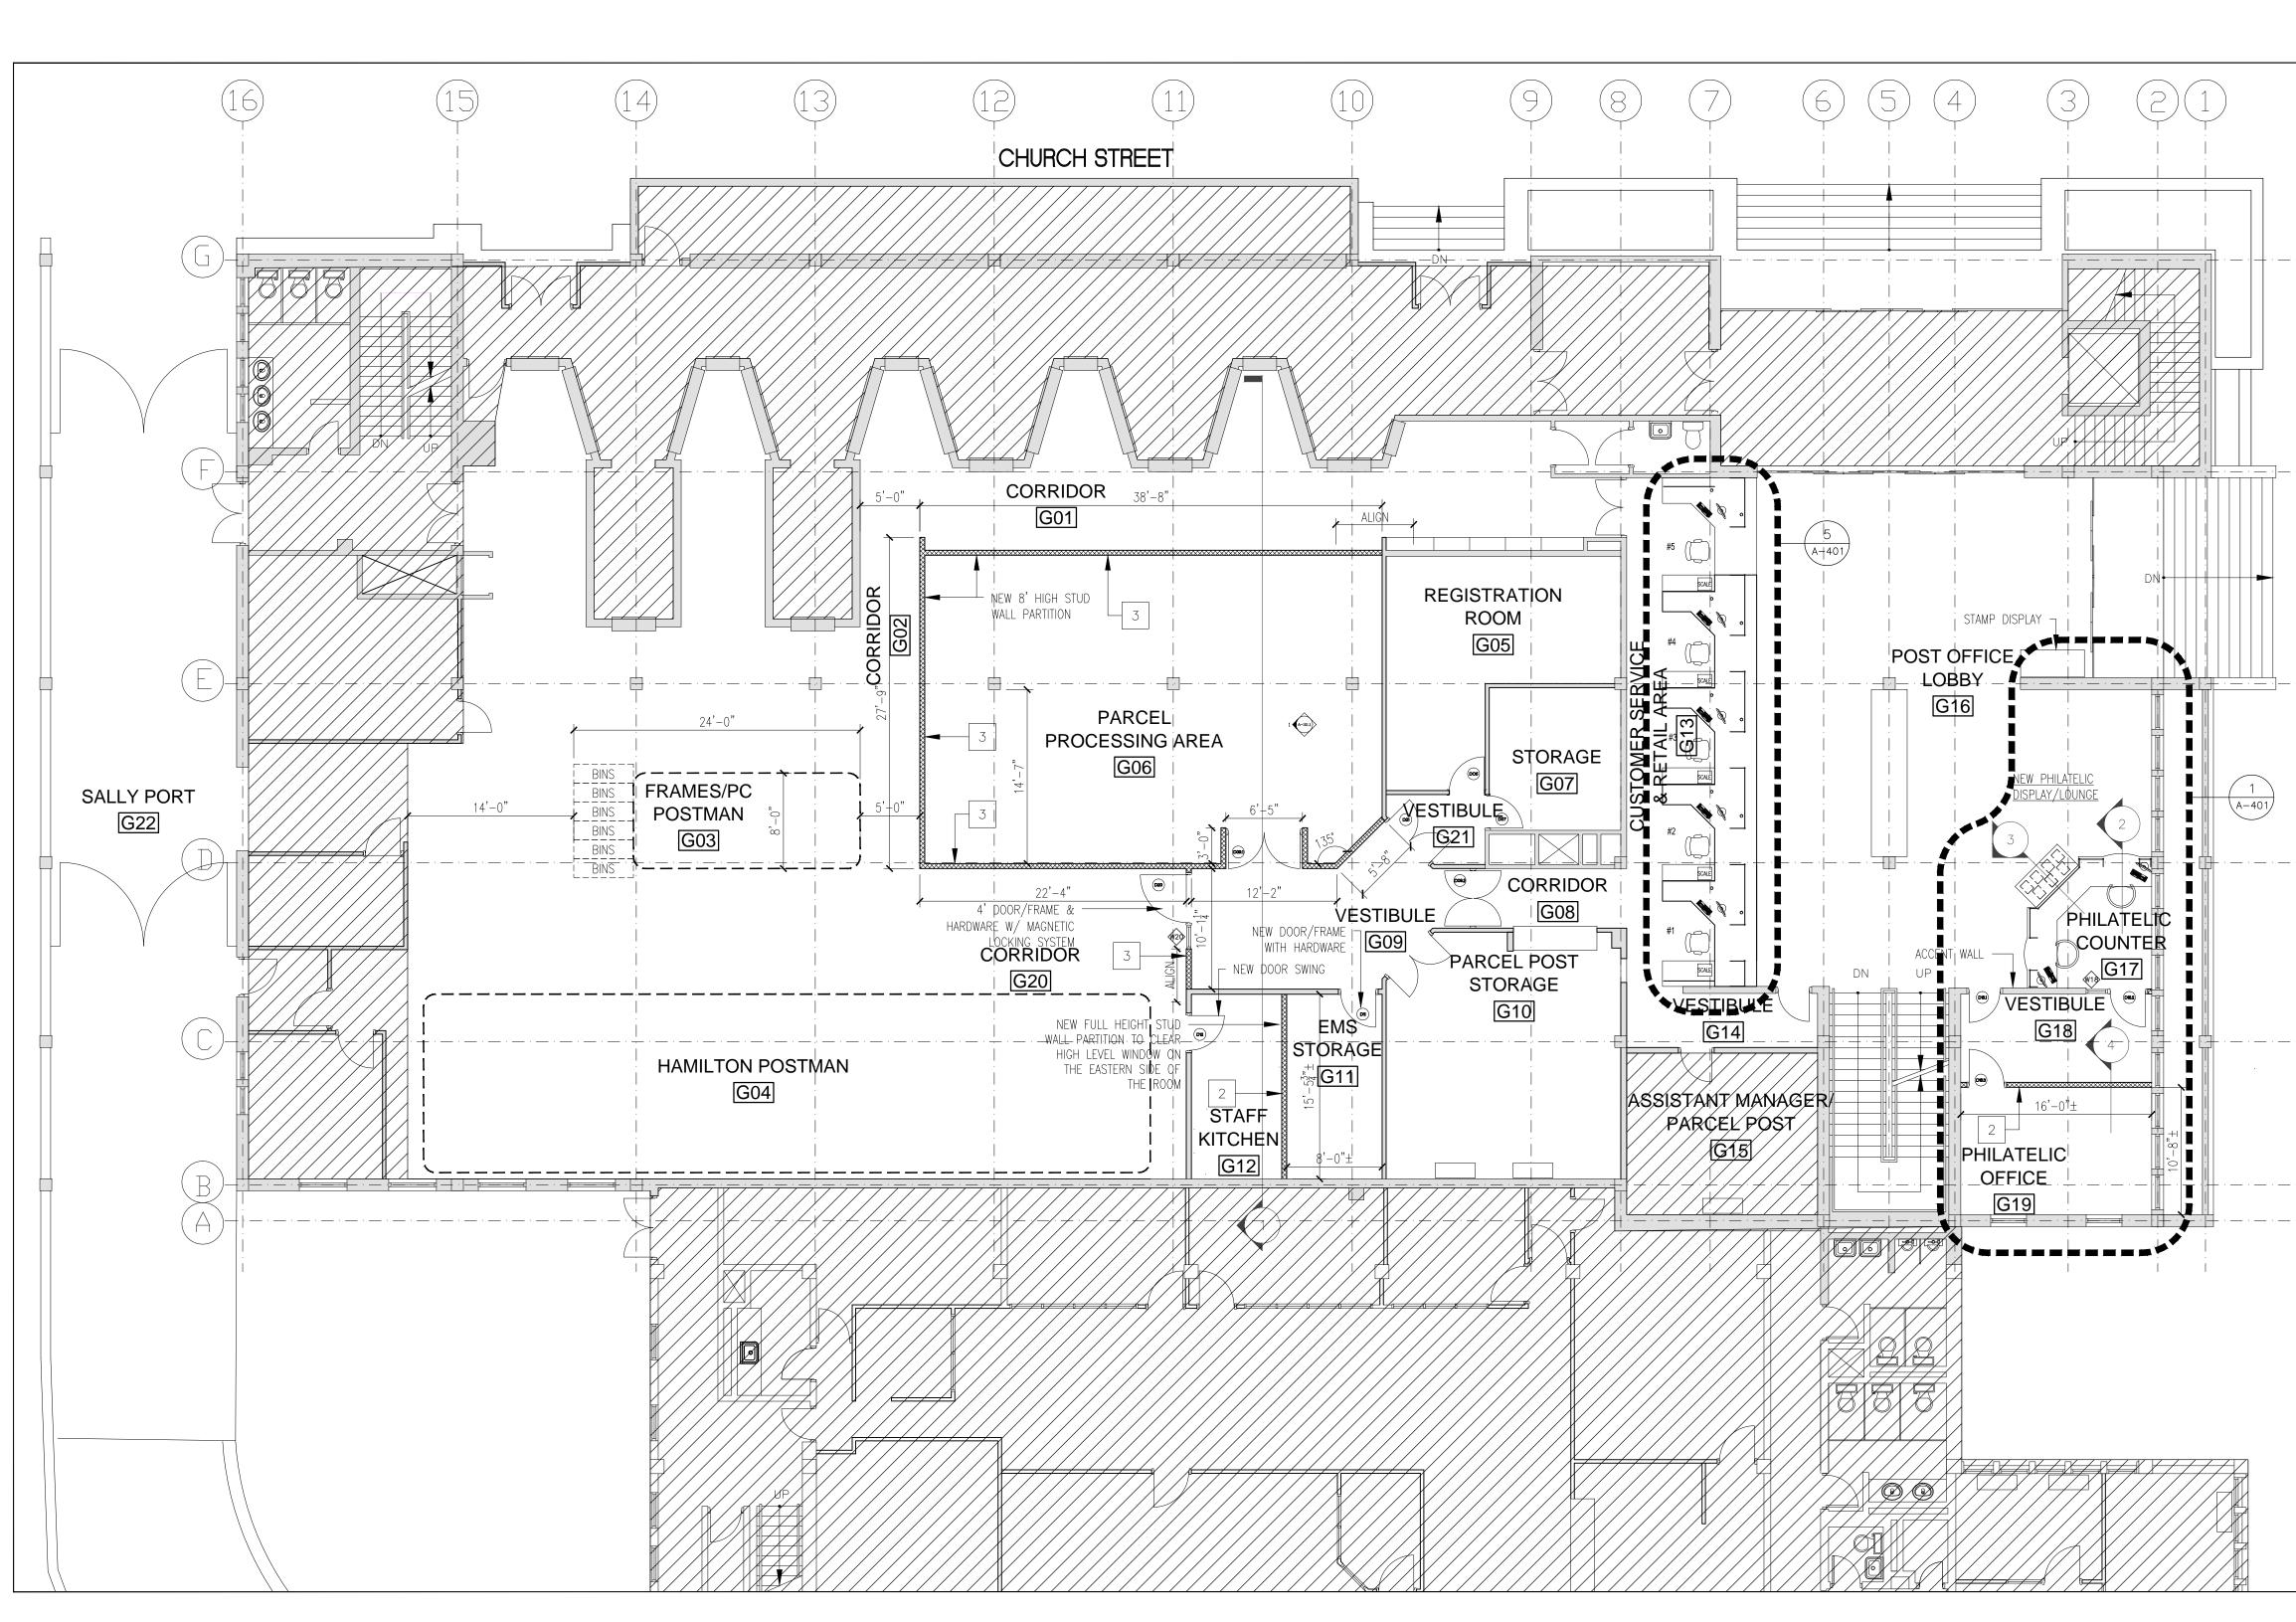
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- 6. CONTRACTOR IS RESPONSIBLE FOR VERIFYING ALL EXISTING CONDITIONS FOR COORDINATION OF WORK TO BE EXECUTED.

7. MAKE GOOD ALL EXISTING WALLS DAMAGED BY DEMOLITION WORK. ALL EXISTING WALLS TO BE MADE GOOD FOR PAINT FINISH. (PAINT BY OTHERS)

8. PROVIDE SUFFICIENT BLOCKING IN ALL AREAS THAT REQUIRE SUPPORT OF WALL OR CEILING MOUNTED EQUIPMENT OR MATERIALS (EG. MILLWORK, SPECIALTY EQUIPMENT, COAT HOOKS,

WINDOW SHADES). BLOCKING TO BE CONCEALED.

9. THESE DRAWINGS ARE TO BE READ IN CONJUNCTION WITH MECHANICAL AND ELECTRICAL DRAWINGS AND SPECIFICATIONS

10. GENERAL CONTRACTOR TO COORDINATE WITH THE FURNITURE VENDOR WITH THE INSTALLATION OF POWER AND COMMUNICATIONS SYSTEM AND ANY OTHER ELECTRICAL REQUIREMENTS.

11. ALL PARTITIONS AND WALLS SHALL HAVE A ULC RATED FIRESTOPPING AND SMOKE SEAL AT ALL FIRE SEPARATIONS

SOUND TRANSMISSION CLASS - RATINGS :

STC 1: 35–40 STC 2: 45–50 STC 3: 55–60

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Project Title:

RELOCATION OF PARCEL POST PROCESSING FUNCTION'S

56 CHURCH STREET GROUND & BASEMENT LEVEL CITY OF HAMILTON BERMUDA

Sheet Title: **PROPOSED GROUND LEVEL DIMENSION PLAN**






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DRAWING SHEET LEGEND:

EXISTING BASE BUILDING

DEMOLITION/REMOVAL

NEW STUD WALL PARTITION

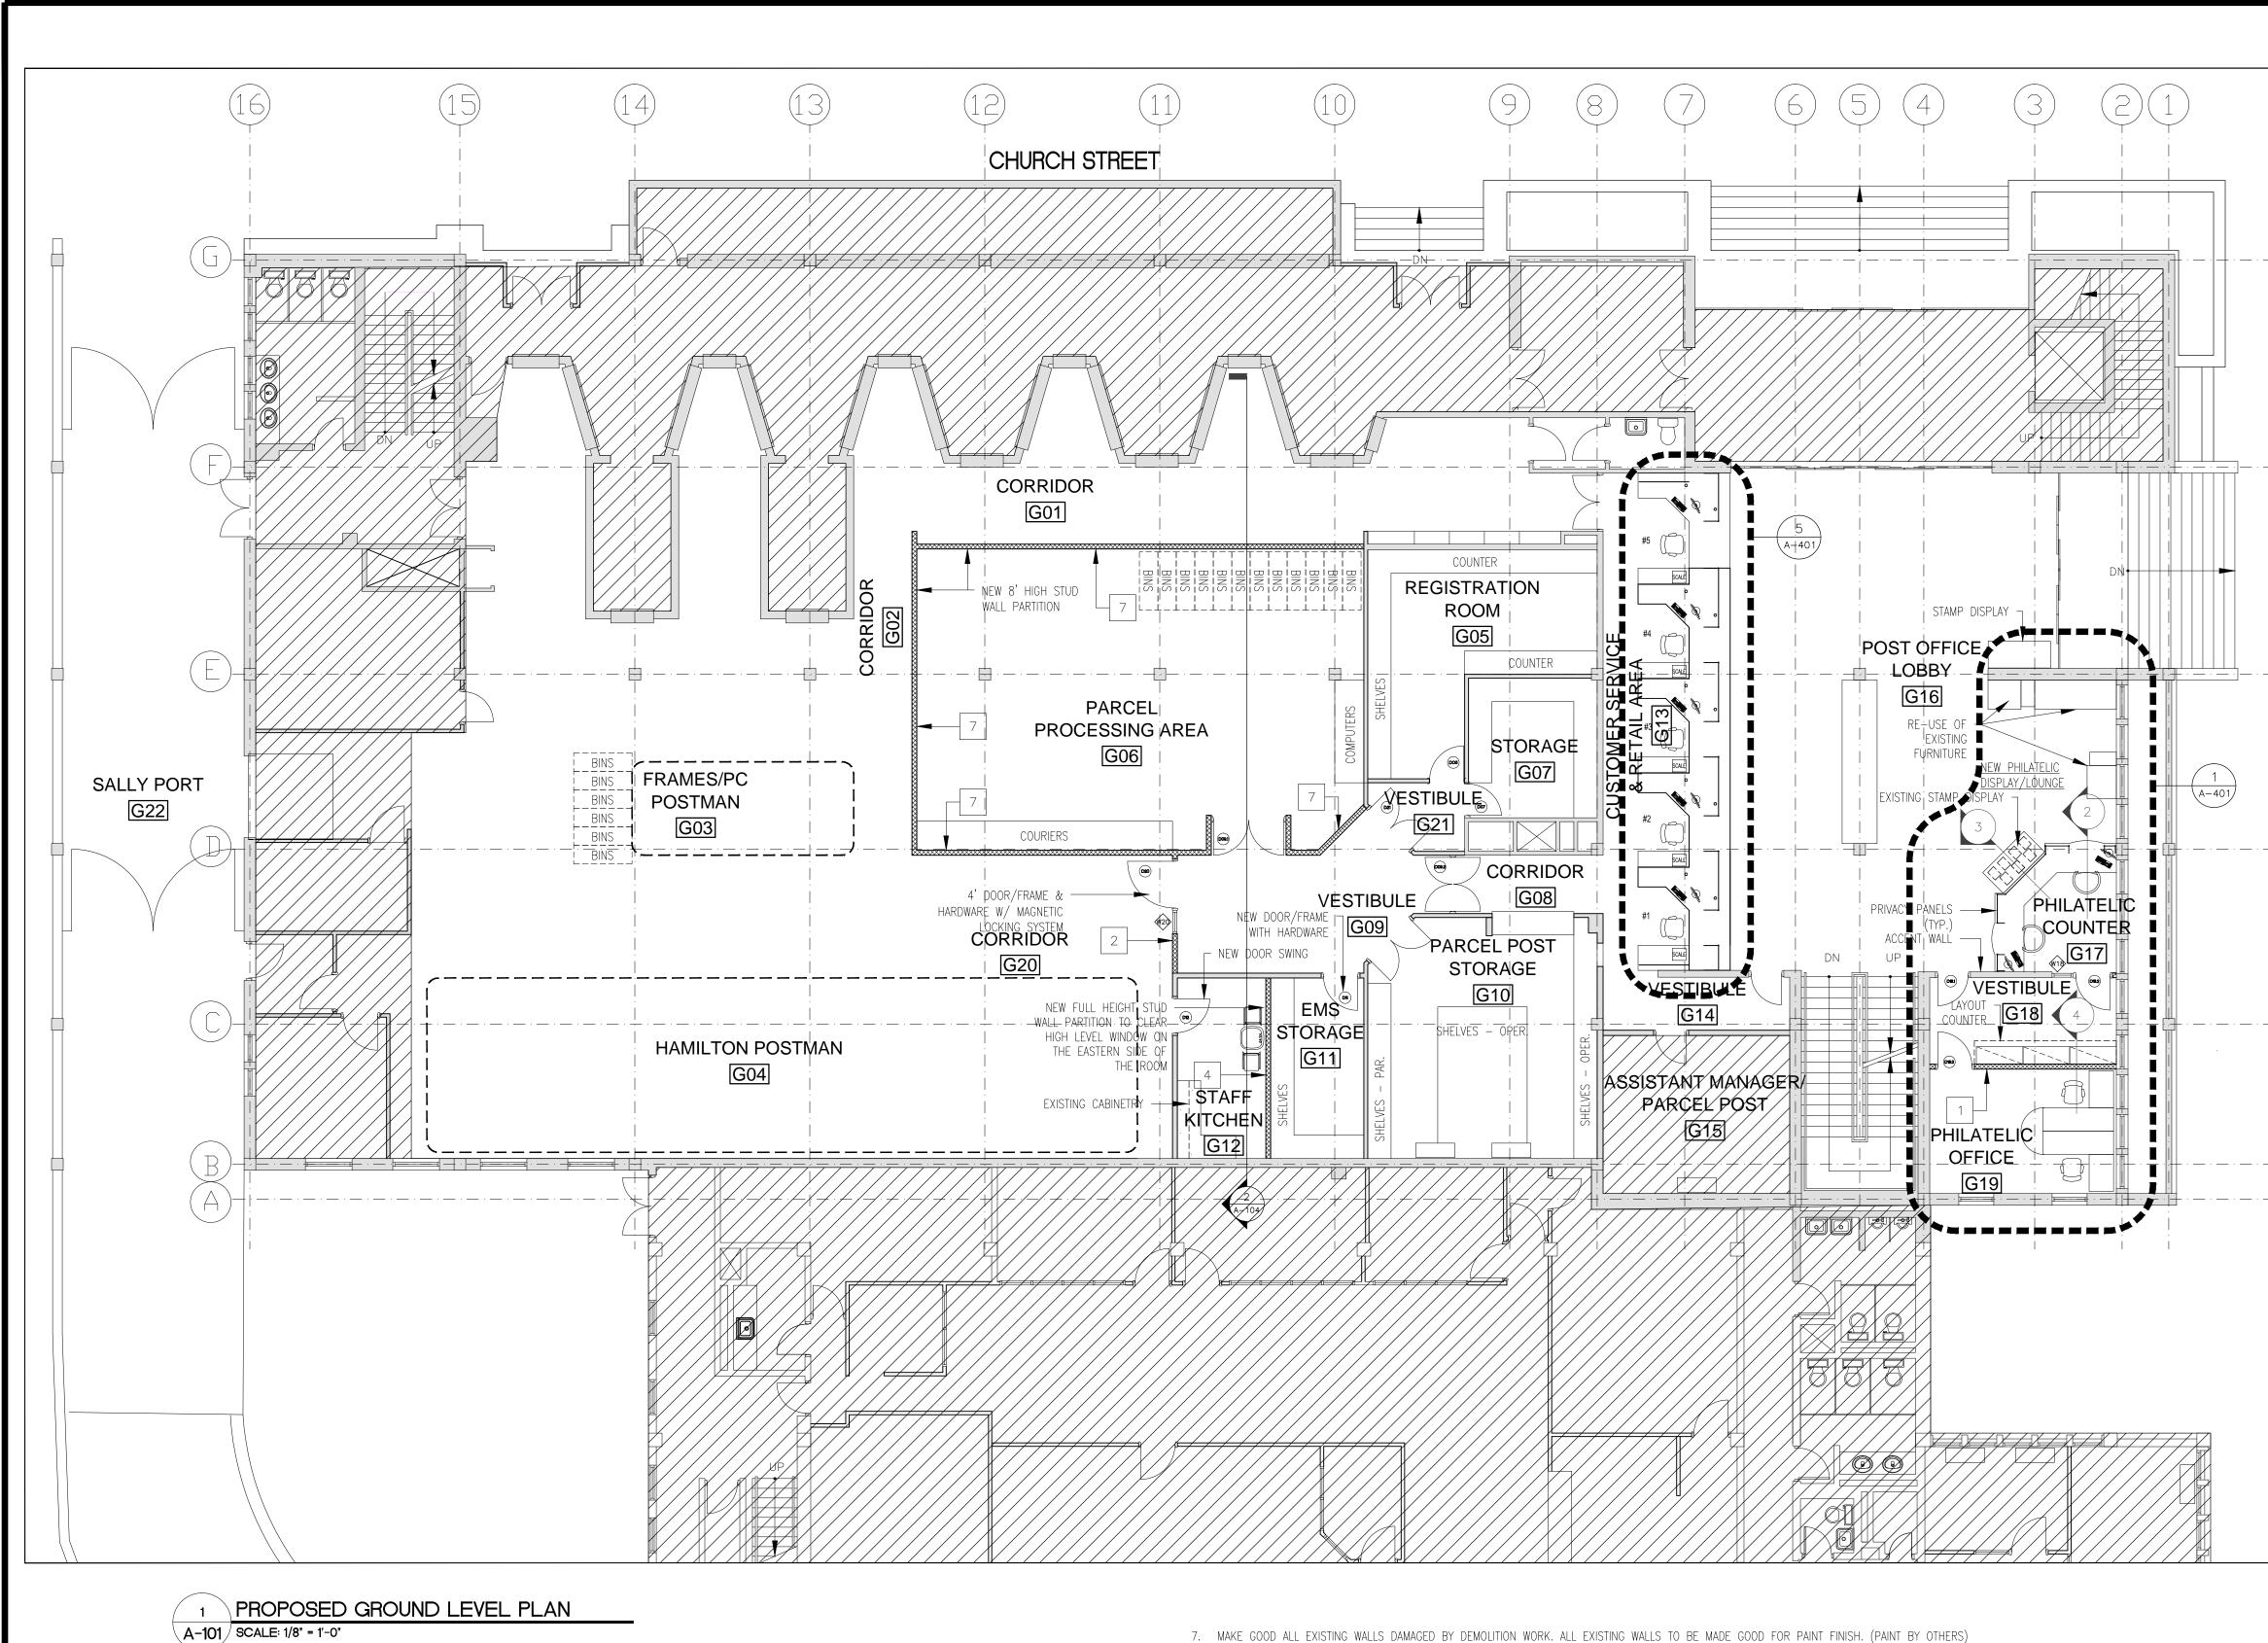

1. CONTRACTOR TO CHALK OUT PARTITION LAYOUT FOR DESIGNER'S APPROVAL PRIOR TO STUD INSTALLATION.

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SOUND TRANSMISSION CLASS - RATINGS :

STC 1: 35-40 STC 2: 45-50 STC 3: 55-60

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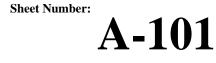
Project Title:

RELOCATION OF PARCEL POST PROCESSING FUNCTION'S

56 CHURCH STREET GROUND & BASEMENT LEVEL CITY OF HAMILTON BERMUDA

Sheet Title: PROPOSED GROUND LEVEL PLAN

Revisions: / - \




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DRAWING SHEET LEGEND:

EXISTING BASE BUILDING

DEMOLITION/REMOVAL

NEW STUD WALL PARTITION

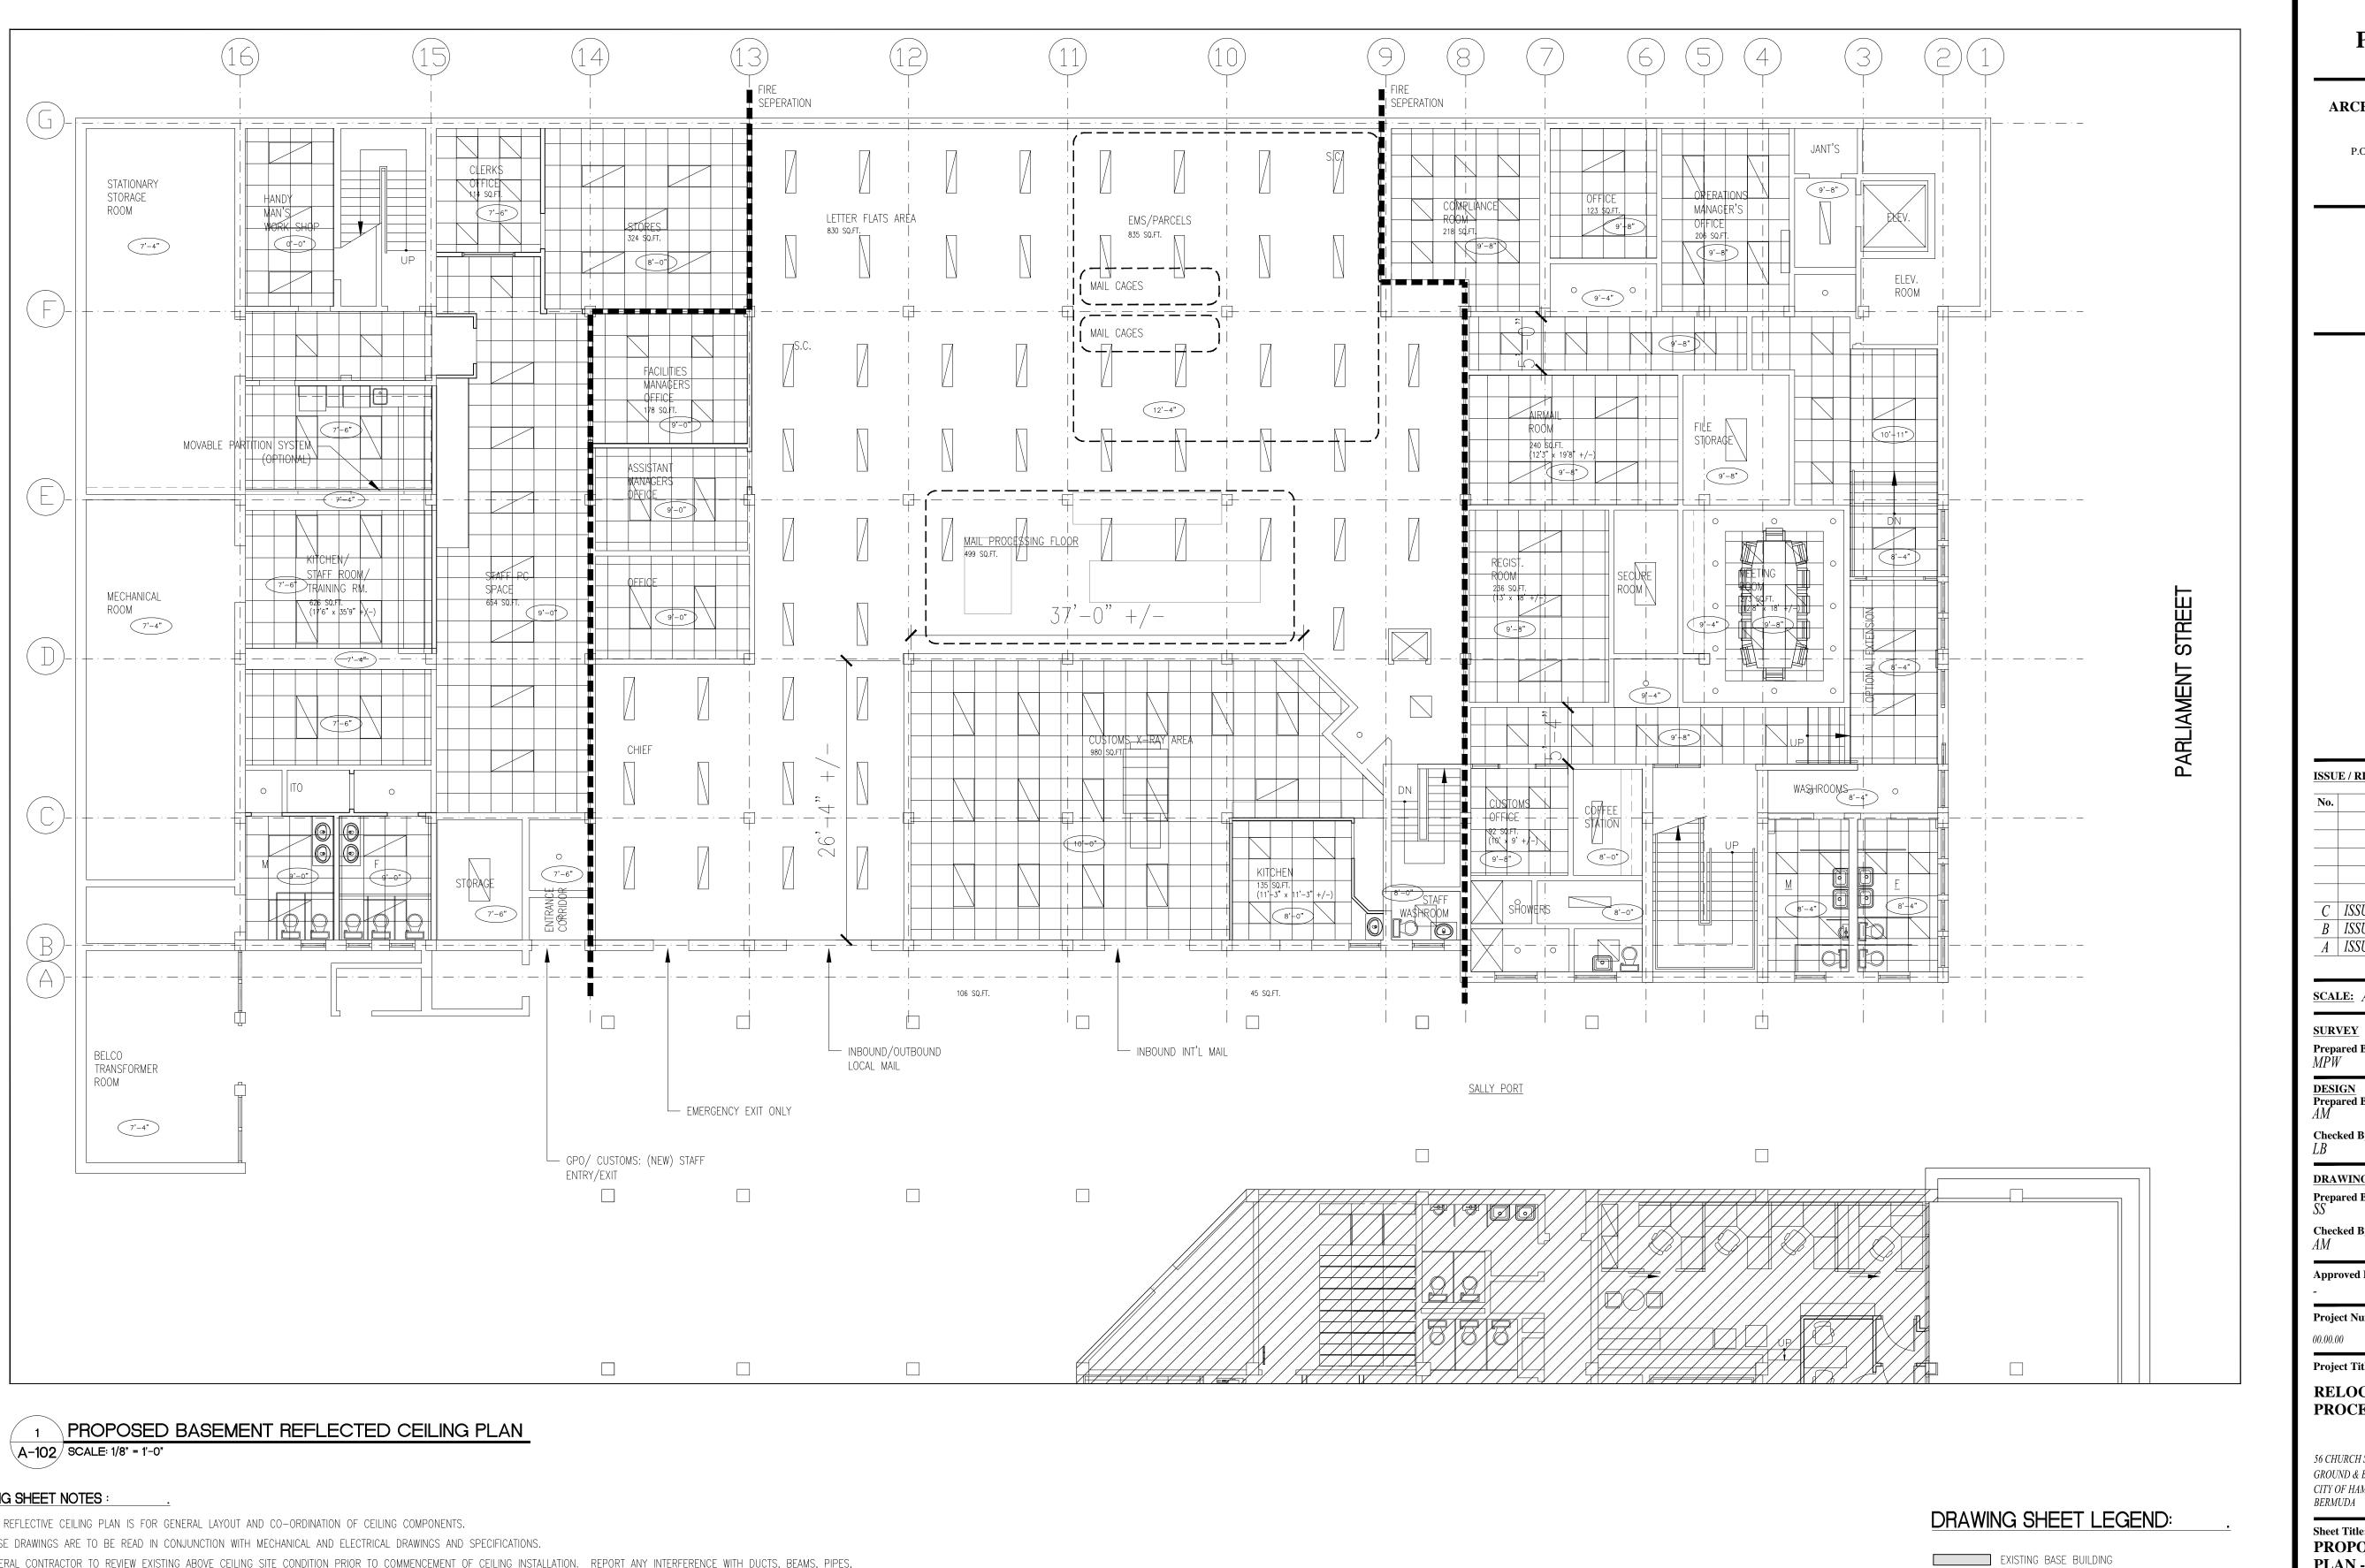

- 1. THE REFLECTIVE CEILING PLAN IS FOR GENERAL LAYOUT AND CO-ORDINATION OF CEILING COMPONENTS.
- 2. THESE DRAWINGS ARE TO BE READ IN CONJUNCTION WITH MECHANICAL AND ELECTRICAL DRAWINGS AND SPECIFICATIONS.
- 3. GENERAL CONTRACTOR TO REVIEW EXISTING ABOVE CEILING SITE CONDITION PRIOR TO COMMENCEMENT OF CEILING INSTALLATION. REPORT ANY INTERFERENCE WITH DUCTS, BEAMS, PIPES, ETC. IMMEDIATELY TO PROJECT MANAGER.
- 4. ANY PROPOSED CHANGES AND/OR MODIFICATIONS DUE TO FIELD CONDITIONS MUST RECEIVE APPROVAL FROM PROJECT MANAGER.
- 5. CLEAN ALL LIGHT FIXTURES UPON COMPLETION OF INSTALLATION.
- 6. IN T-BAR CEILING AREAS ALL CEILING MOUNTED DEVICES TO BE CENTERED WITHIN THE CEILING TILE, UNLESS OTHER WISE NOTED.
- 7. DRYWALL CONTRACTOR IS RESPONSIBLE FOR ALL CEILING ALTERATIONS, CUTTING, PATCHING, ETC.
- 8. SMOKE DETECTORS, HEAT DETECTORS, PA SPEAKERS ETC SHALL BE LOCATED IN THE CENTER OF CEILING TILE.

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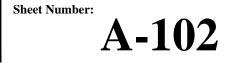
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RELOCATION OF PARCEL POST PROCESSING FUNCTION'S

56 CHURCH STREET GROUND & BASEMENT LEVEL CITY OF HAMILTON BERMUDA


Sheet Title: PROPOSED REFLECTED CEILING PLAN - BASEMENT

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NEW STUD WALL PARTITION

DEMOLITION/REMOVAL





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DRAWING SHEET LEGEND:	56 CHURCH STREET GROUND & BASEMENT LEVEL CITY OF HAMILTON BERMUDA
EXISTING BASE BUILDING EXISTING BASE BUILDING DEMOLITION/REMOVAL NEW STUD WALL PARTITION	Sheet Title: PROPOSED REFLECTED CEILING PLAN - GROUND LEVEL

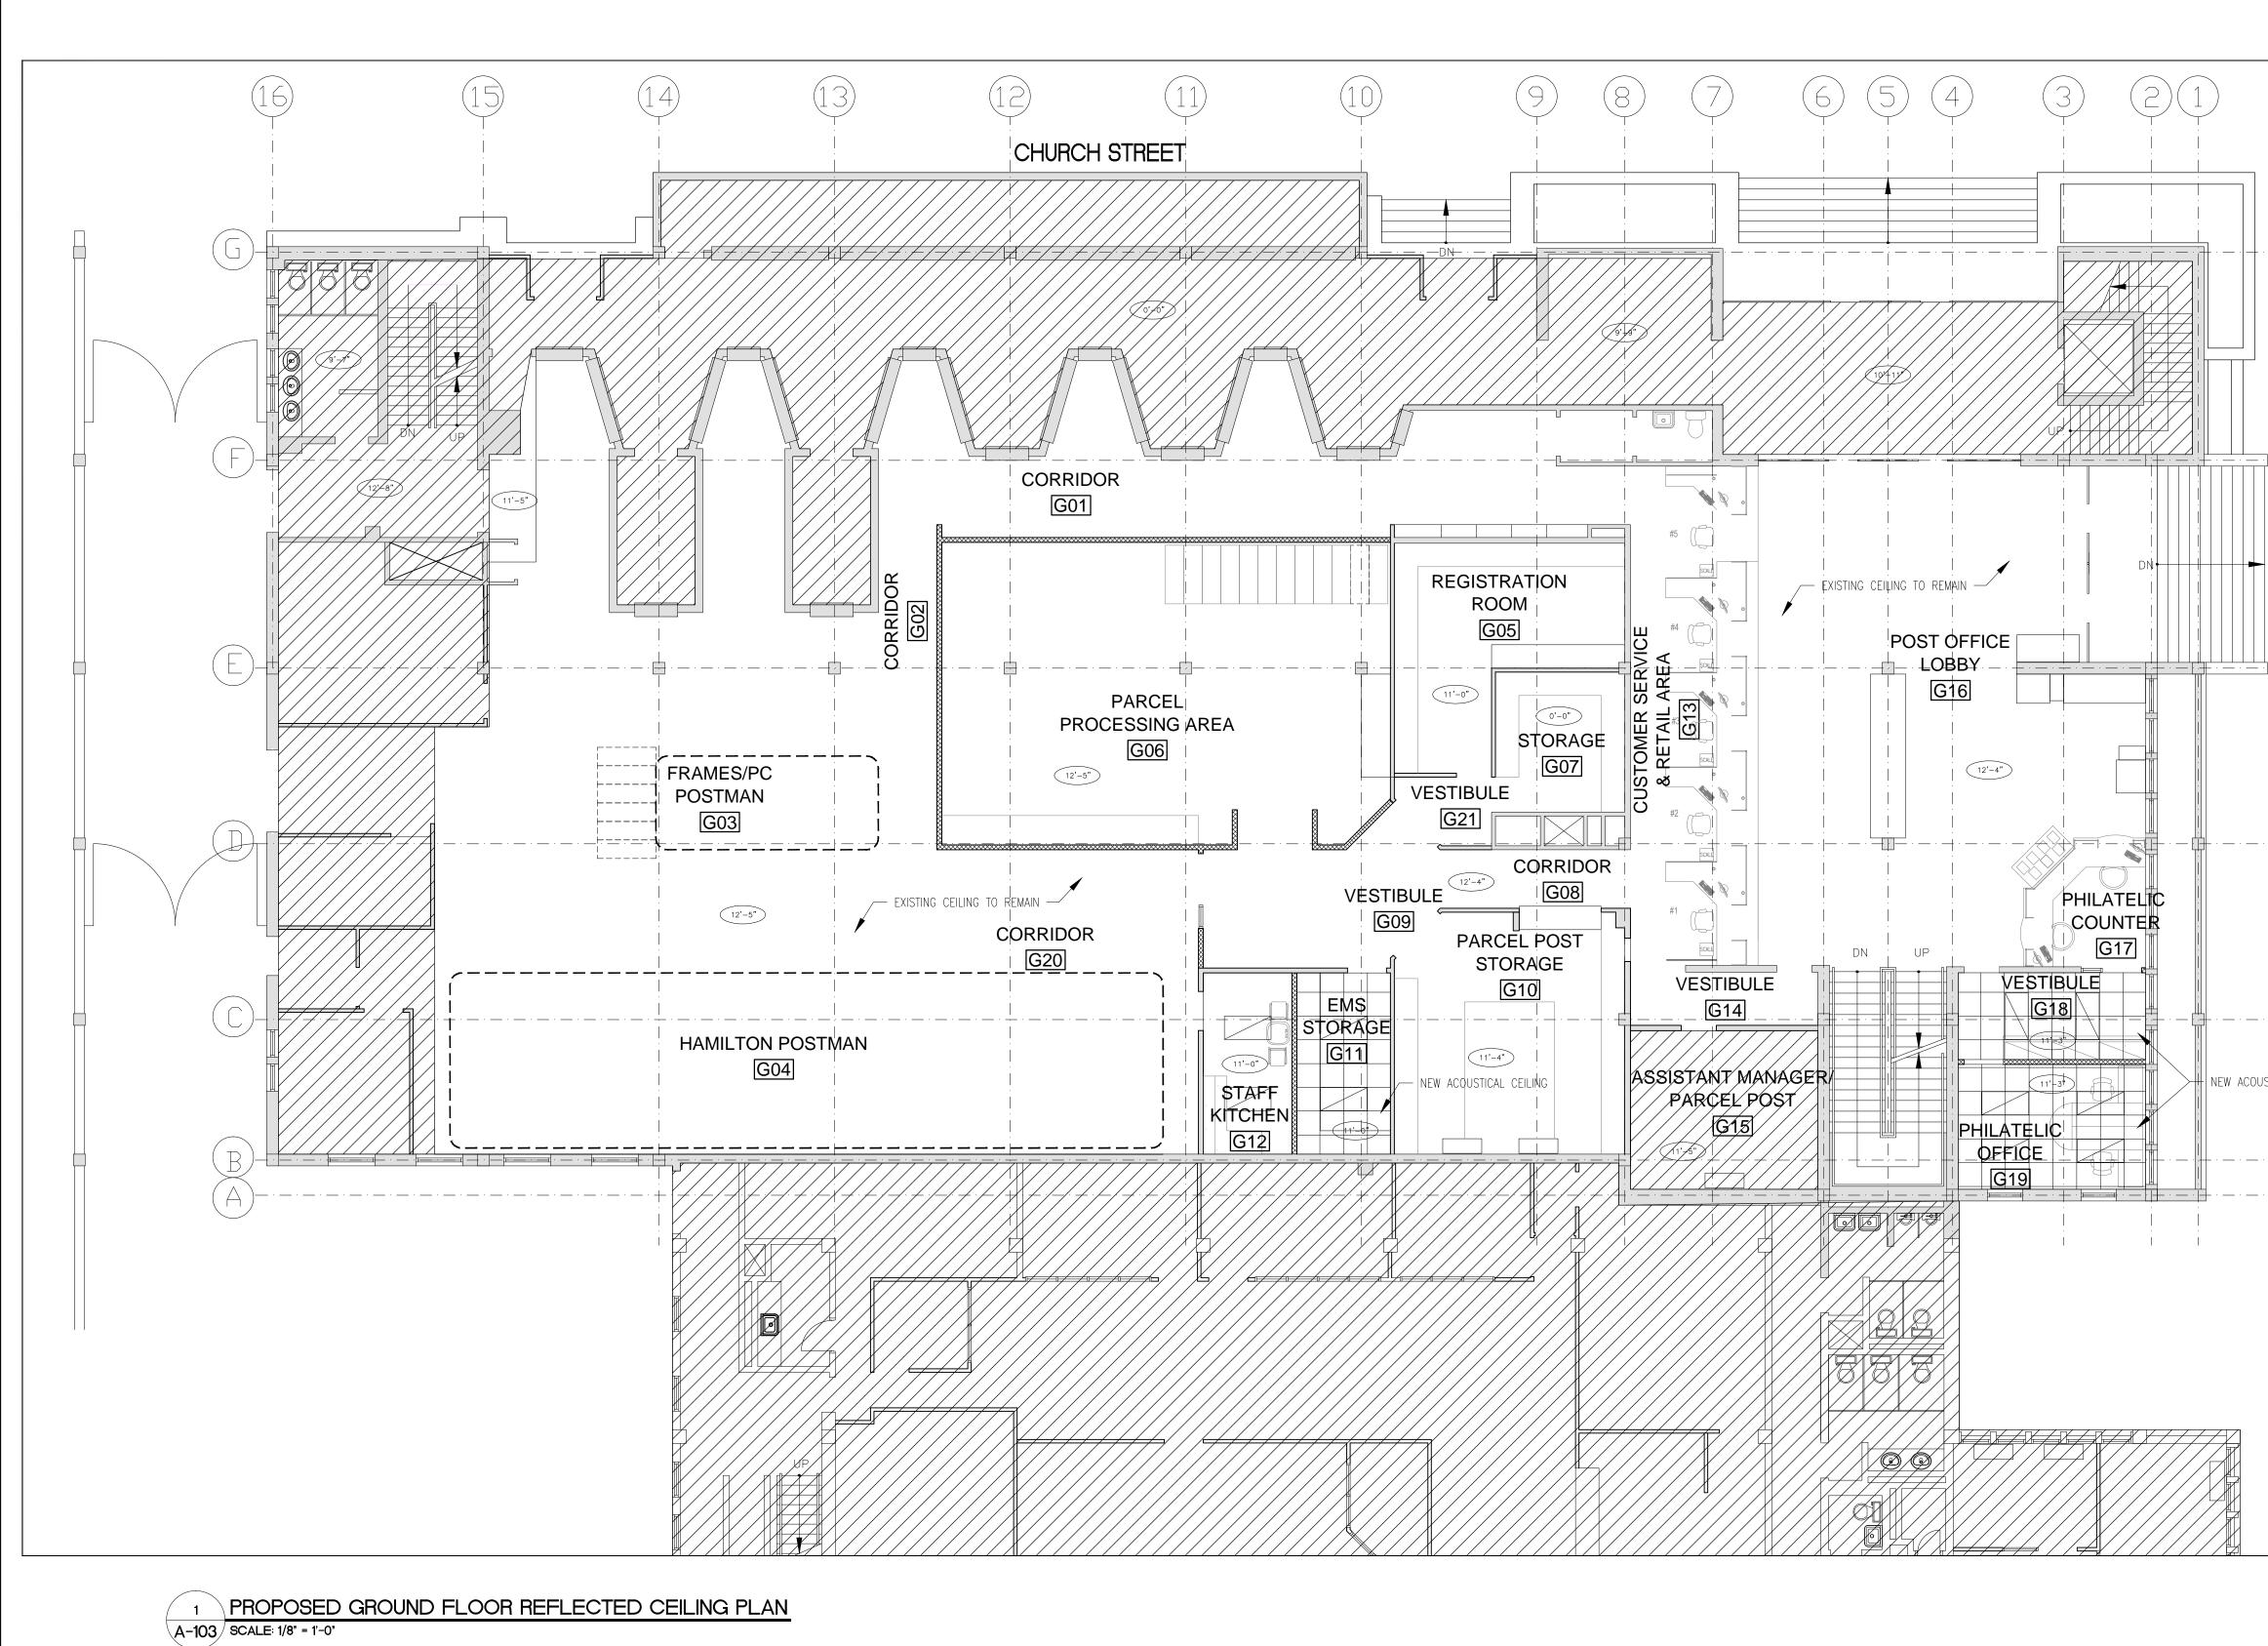
SHADED AREA INDICATES NOT IN CONTRACT

Revisions: _



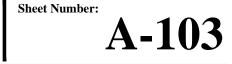

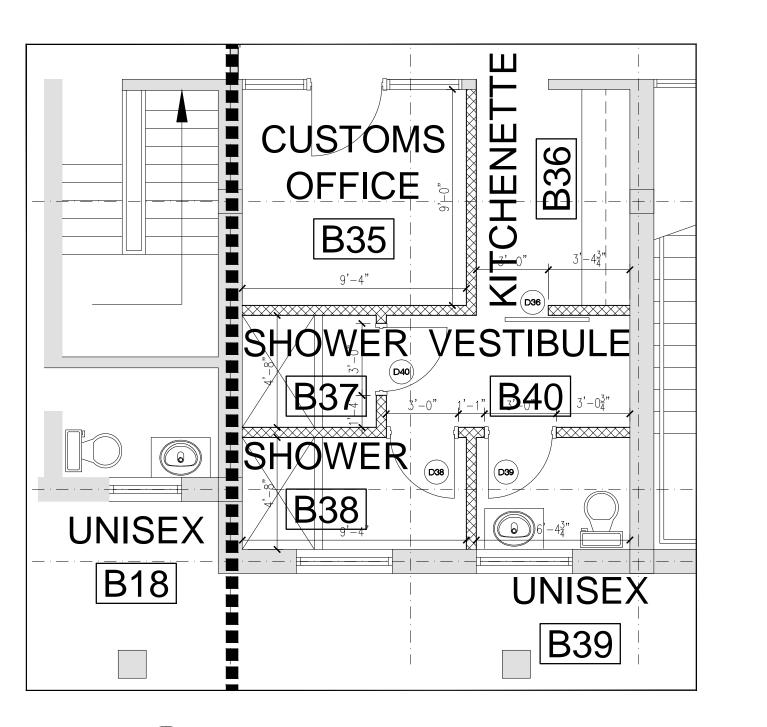PROPOSED GROUND FLOOR REFLECTED CEILING PLAN 1 A-104 SCALE: 1/4" = 1'-0"

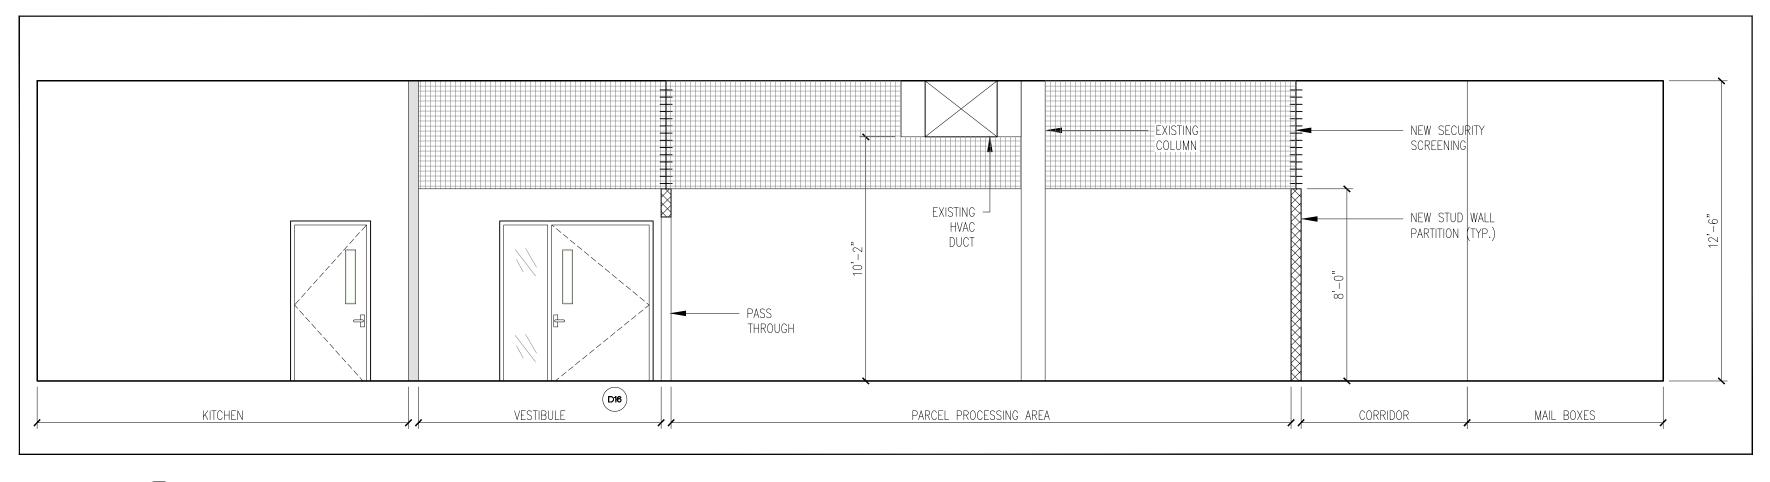

2 PROPOSED GROUND LEVEL PROCESSING AREA - INTERIOR ELEVATION A-104 SCALE: 1/4" = 1'-0"

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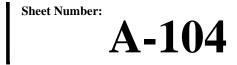
Project Title:

RELOCATION OF PARCEL POST PROCESSING FUNCTION'S

56 CHURCH STREET GROUND & BASEMENT LEVEL CITY OF HAMILTON BERMUDA

Sheet Title: PROPOSED DRAWINGS

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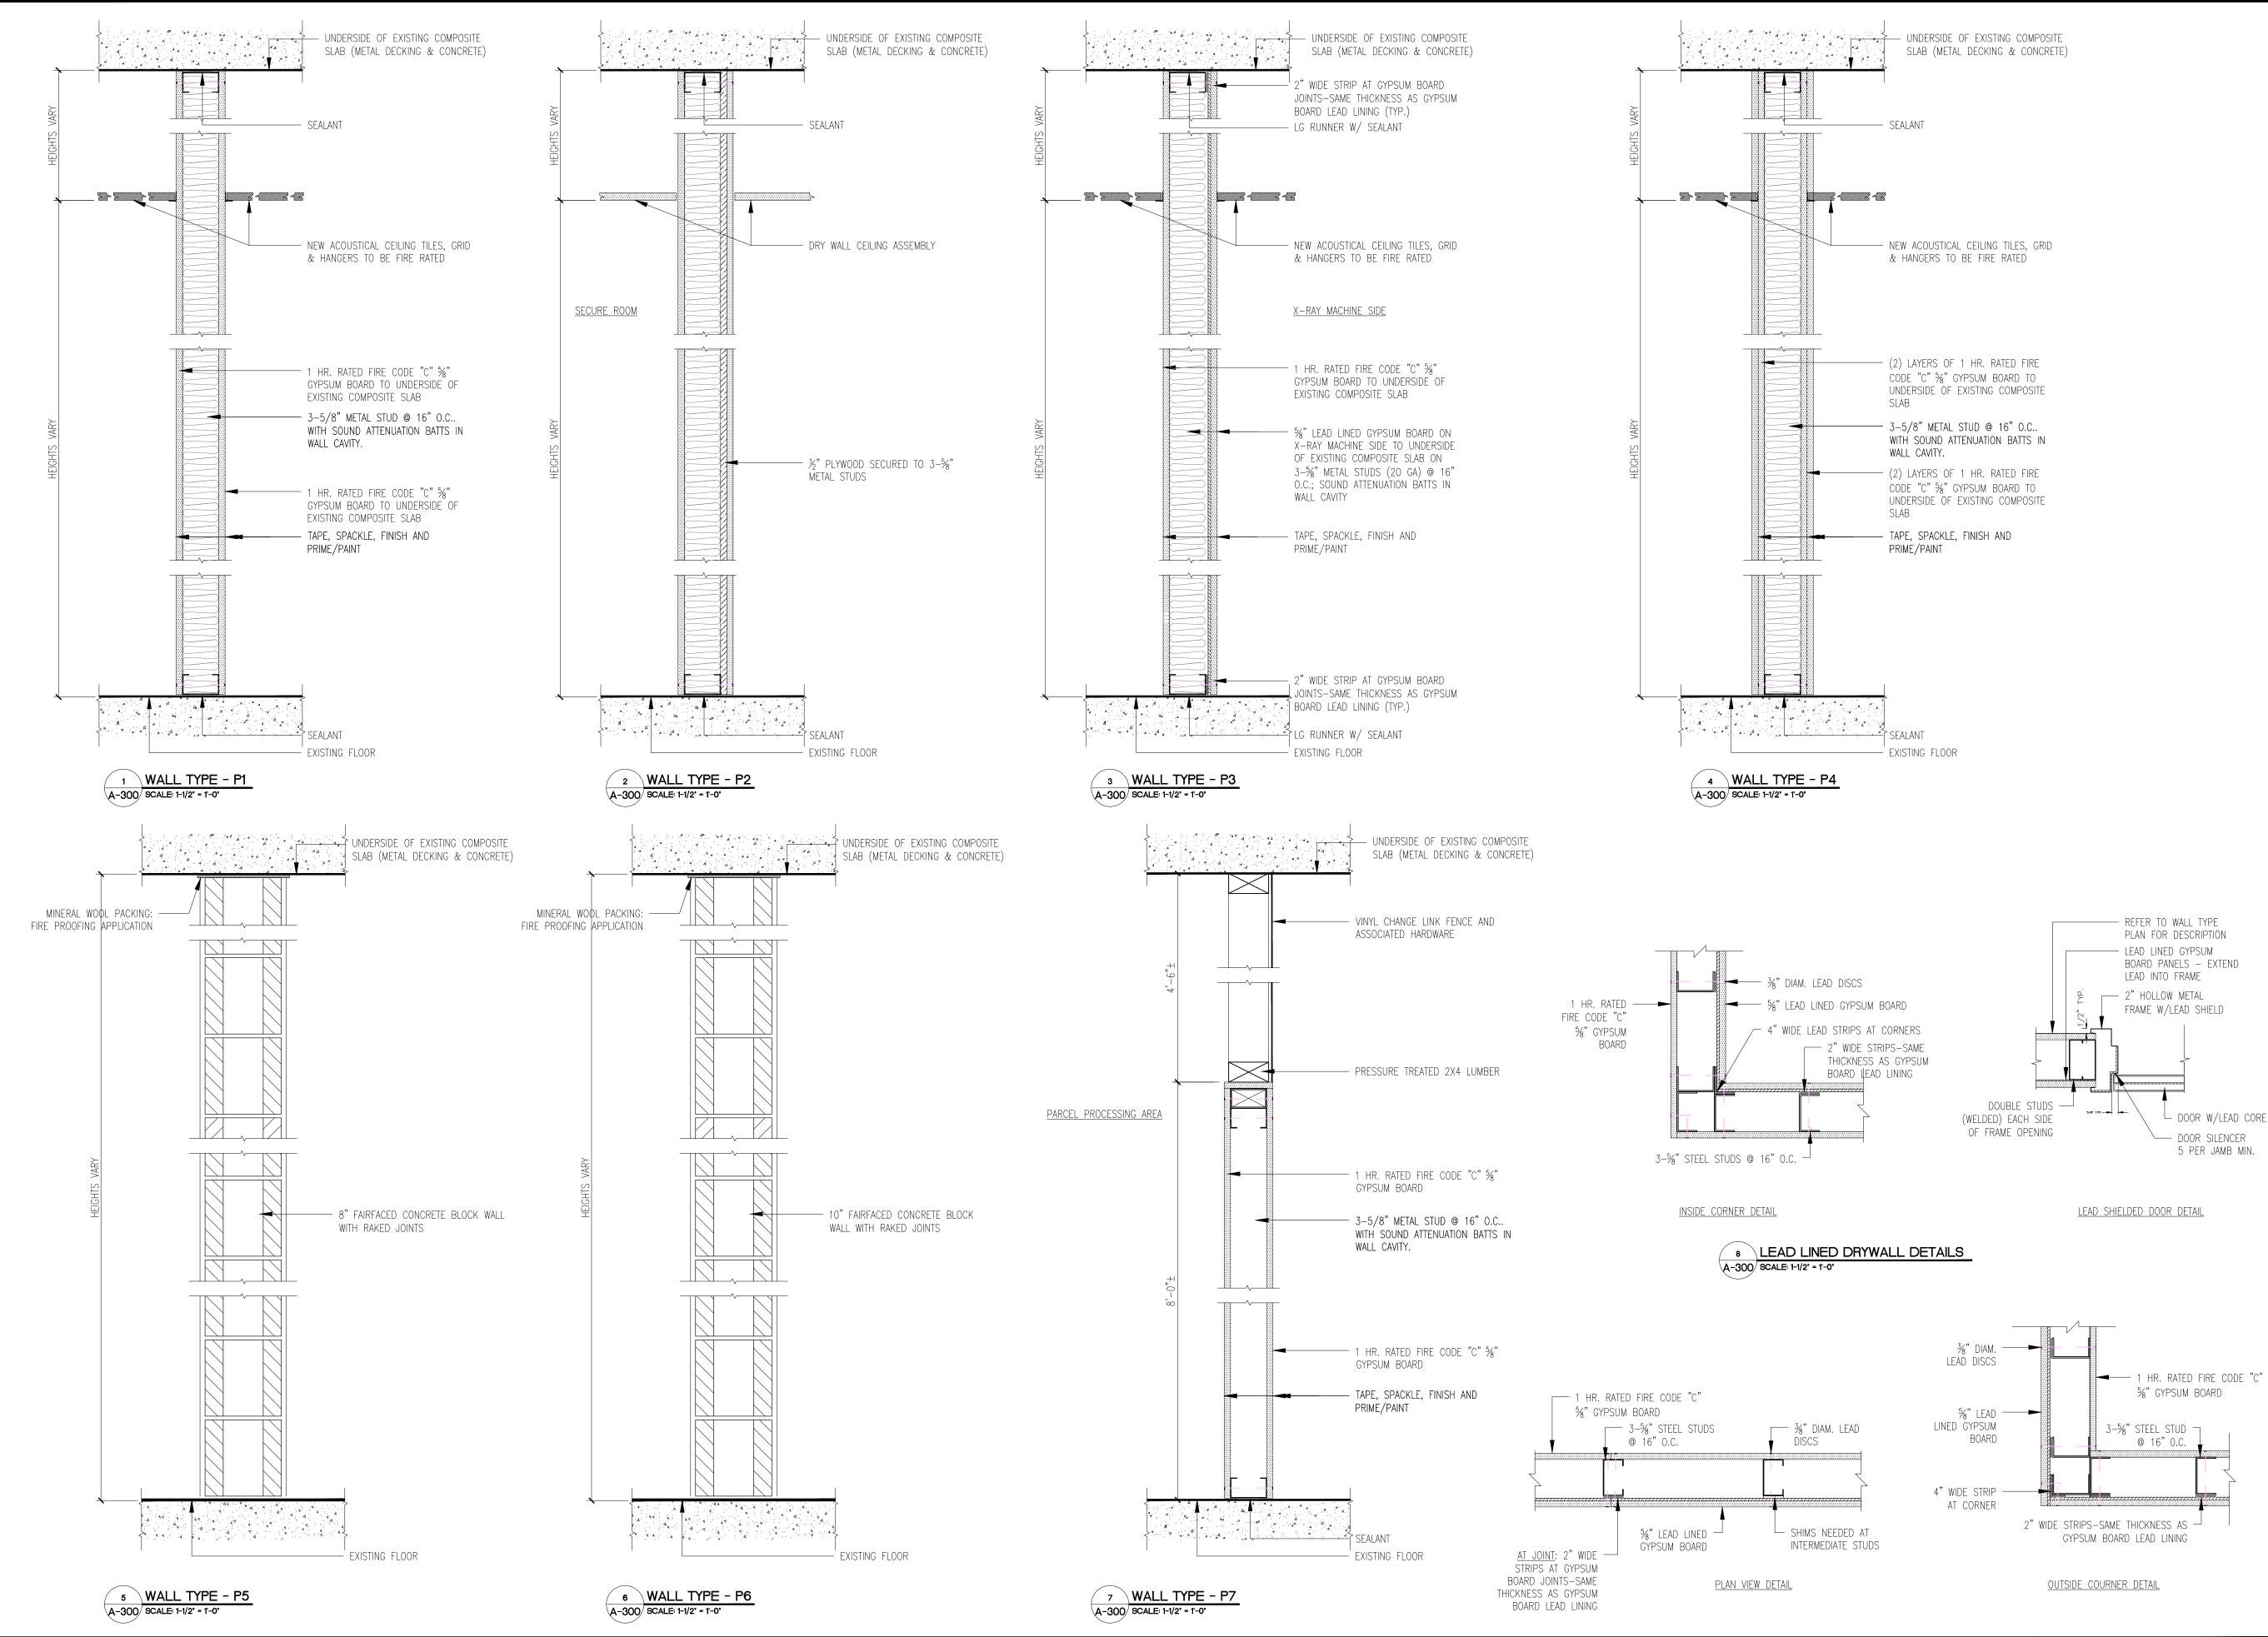


DRAWING SHEET LEGEND:

EXISTING BASE BUILDING

_____ DEMOLITION/REMOVAL

NEW STUD WALL PARTITION



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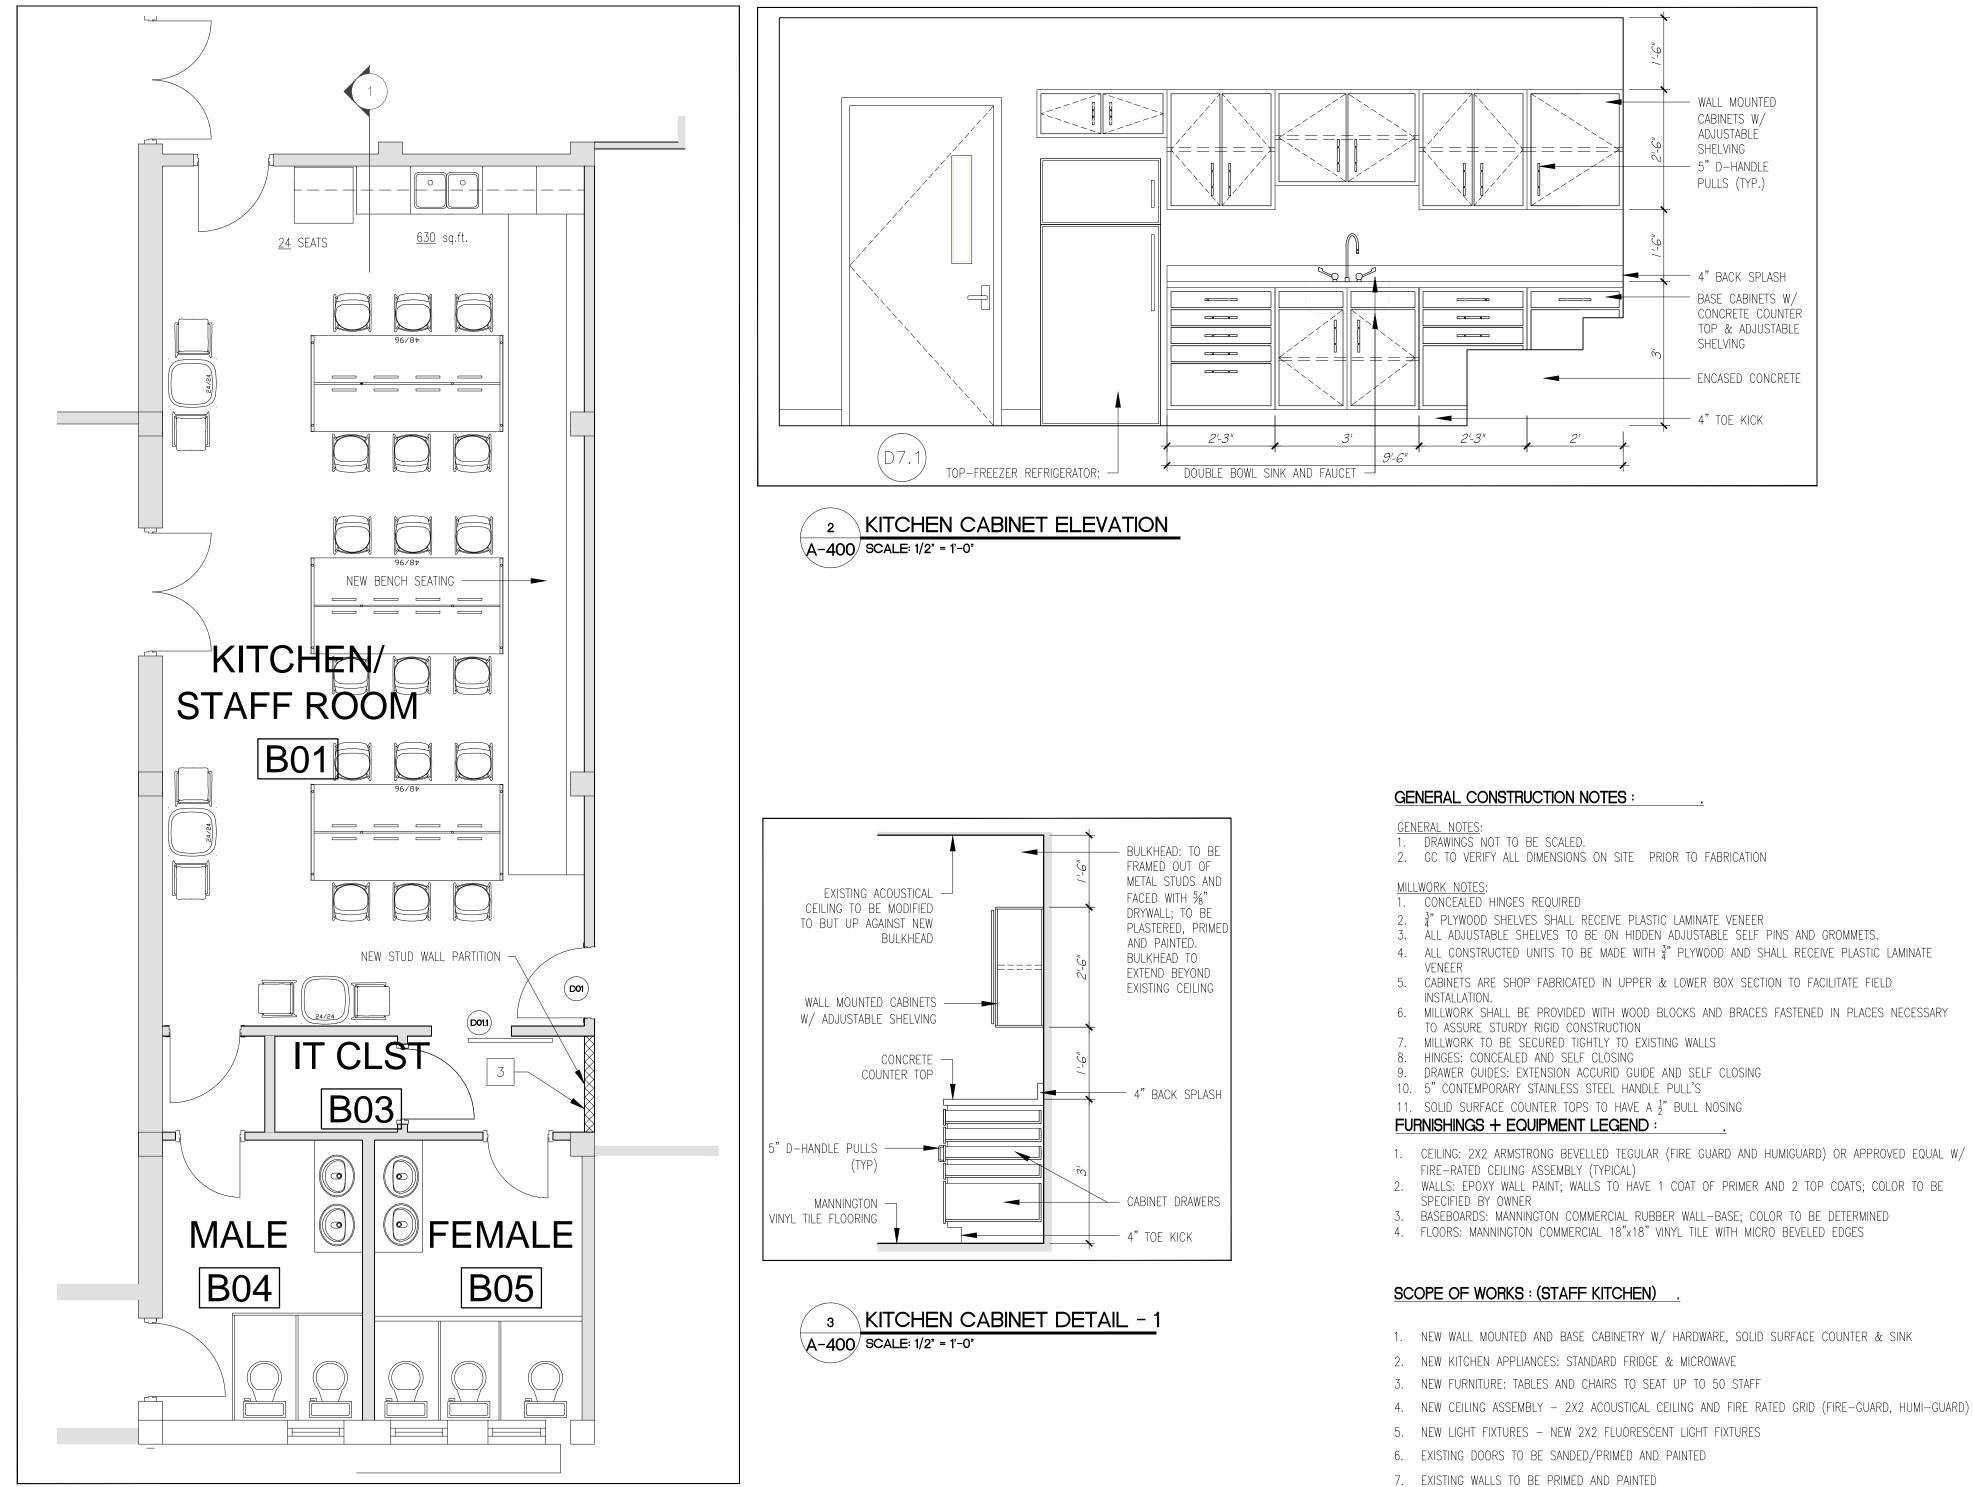
RELOCATION OF PARCEL POST PROCESSING FUNCTION'S

56 CHURCH STREET GROUND & BASEMENT LEVEL CITY OF HAMILTON BERMUDA

Sheet Title: **TYPICAL WALL TYPES**

Sheet Number: **Revisions:** / - \





PROPOSED STAFF KITCHEN A-400 SCALE: 1/4" = 1'-0"

- 3. ALL ADJUSTABLE SHELVES TO BE ON HIDDEN ADJUSTABLE SELF PINS AND GROMMETS.
- 4. ALL CONSTRUCTED UNITS TO BE MADE WITH $\frac{3}{4}$ " PLYWOOD AND SHALL RECEIVE PLASTIC LAMINATE

- 3. BASEBOARDS: MANNINGTON COMMERCIAL RUBBER WALL-BASE; COLOR TO BE DETERMINED

- 1. NEW WALL MOUNTED AND BASE CABINETRY W/ HARDWARE, SOLID SURFACE COUNTER & SINK

- 4. NEW CEILING ASSEMBLY 2X2 ACOUSTICAL CEILING AND FIRE RATED GRID (FIRE-GUARD, HUMI-GUARD)


- 8. TILE BACK SPLASH FROM COUNTER TO UNDERSIDE OF WALL MOUNTED CABINETS
- 9. FLOOR BASE BOARD VINYL BASE BOARD (HEAVY GRADE)
- 10. FLOOR FINISH VCT (STAIN RESISTANT, SLIP RESISTANT) CURRENTLY CERAMIC INSTALLED
- 11. ELECTRICAL TO BE ASSESSED BY AN ELECTRICAL ENGINEER
- 12. MECHANICAL (HVAC) MODIFICATIONS TO EXISTING SUPPLY & EXHAUST
- 13. LIFE SAFETY NEW HEAT DETECTOR/FIRE EXTINGUISHER
- 14. VOICE/DATA PROVISIONS FOR ONE OUTLET (4 POINTS)

MINISTRY OF PUBLIC WORKS


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ROL	IND FLR. Governn				Ink	MATERIAL	FINISH	GLAZING	TIPE	SIZE		FINISF		No.	ELEC HOLDER	CLOSER	FLOOR STOP	NCAPLATE	WALL STOP	
D05	REGISTRATION ROOM	A	3'-0"	6'-8"	1-3/4"	WD/SOLID CORE	STAIN VARNISH	3/16" FIRE RATED GLASS	A	2"X4"	WD	STAIN VARNISH	1HR	HS-2	YES	YES	YES	YES	_	
D07	STORAGE	A	3'-0"	6'-8"	1-3/4"	WD/SOLID CORE	STAIN VARNISH	3/16" FIRE RATED GLASS	A	2"X4"	WD	STAIN VARNISH	1HR	HS-2	YES	YES	YES	YES	_	
D21	VESTIBULE	в	(2) 3'-0"	6'-8"	1-3/4"	WD/SOLID CORE	STAIN VARNISH	3/16" FIRE RATED GLASS	A	2"X4"	WD	STAIN VARNISH	3/4Hr	HS-1	_	YES	YES	YES	_	
D09.1	VESTIBULE	в	(2) 3'-0"	6'-8"	1-3/4"	WD/SOLID CORE	STAIN VARNISH	3/16" FIRE RATED GLASS	A	2"X4"	WD	STAIN VARNISH	3/4Hr	HS-2	-	YES	YES	YES	-	
D20	CORRIDOR	с	4'-0"	6'-8"	1-3/4"	WD/SOLID CORE	STAIN VARNISH	3/16" FIRE RATED GLASS	А	2"X4"	WD	STAIN VARNISH	1HR	HS-1	YES	YES	YES	YES	_	
D12	STAFF KITCHEN	н	3'-0"	6'-8"	1-3/4"	НМ	PT-SPRAYED WITH ENAMEL	3/16" FIRE RATED GLASS	В	2"X4"	НМ	PT-SPRAYED WITH ENAMEL	1HR	HS-1	-	YES	YES	-	-	
D11	EMS STORAGE	A	3'-0"	6'-8"	1-3/4"	WD/SOLID CORE	STAIN VARNISH	3/16" FIRE RATED GLASS	A	2"X4"	WD	STAIN VARNISH	1Hr	HS-2	-	YES	YES	YES	-	
D09.2	VESTIBULE	D	(2) 3'-0"	6'-8"	1-3/4"	WD/SOLID CORE	STAIN VARNISH	3/16" FIRE RATED GLASS	A	2"X4"	WD	STAIN VARNISH	3/4Hr	-	-	-	YES	YES	-	DC
D18.1	VESTIBULE	A	3'-0"	6'-8"	1-3/4"	WD/SOLID CORE	STAIN VARNISH	3/16" FIRE RATED GLASS	A	2"X4"	WD	STAIN VARNISH	1Hr	HS-1	YES	YES	YES	-	-	
D18.2	VESTIBULE	н	3'-0"	6'-8"	1-3/4"	НМ	PT-SPRAYED WITH ENAMEL	3/16" FIRE RATED GLASS	A	2"X4"	НМ	PT-SPRAYED WITH ENAMEL	1Hr	HS-2	YES	YES	YES	_	_	
D18.3	VESTIBULE	A	3'-0"	6'-8"	1-3/4"	WD/SOLID CORE	STAIN VARNISH	3/16" FIRE RATED GLASS	A	2"X4"	WD	STAIN VARNISH	1Hr	HS-3	YES	YES	YES	_	_	+
BASE	MENT FLR. Gove	rnmen	t Post C	Office													· · · · ·			<u> </u>
D41.1	STORAGE CLOSET	E	(2) 2'-6"	6'-8"	1-3/4"	WD	STAIN VARNISH	-	A	2"X4"	WD	STAIN VARNISH	1HR	HS-2	-	-	-	-	-	
D41.2	STORAGE CLOSET	E	(2) 2'-6"	6'-8"	1-3/4"	WD	STAIN VARNISH	-	A	2"X4"	WD	STAIN VARNISH	1HR	HS-2	-	-	-	-	-	
D41.3	STORAGE CLOSET	E	(2) 2'-6"	6'-8"	1-3/4"	WD	STAIN VARNISH	-	A	2"X4"	WD	STAIN VARNISH	1HR	HS-2	-	-	_	-	-	
D01	KITCHEN/STAFF ROOM	н	3'-0"	6'-8"	1-3/4"	НМ	PT-SPRAYED WITH ENAMEL	3/16" FIRE RATED GLASS	A	2"X4"	WD	PT-SPRAYED WITH ENAMEL	1HR	HS-1	YES	YES	YES	YES	-	
D01.1	KITCHEN/STAFF ROOM	F	3'-0"	6'-8"	1-3/4"	WD/SOLID CORE	STAIN VARNISH	-	A	2"X4"	WD	STAIN VARNISH	1HR	HS-2	-	YES	YES	YES	-	PC
D07	ASSISTANT MANAGERS OFFICE	А	3'-0"	6'-8"	1-3/4"	WD/SOLID CORE	STAIN VARNISH	-	A	2"X4"	WD	STAIN VARNISH	1HR	HS-2	-	YES	YES	YES	-	
D08	OFFICE	A	3'-0"	6'-8"	1-3/4"	WD/SOLID CORE	STAIN VARNISH	_	А	2"X4"	WD	STAIN VARNISH	1HR	HS-2	_	YES	YES	YES	_	
D09	MAIL PROCESSING FLOOR	A	3'-0"	6'-8"	1-3/4"	WD/SOLID CORE	STAIN VARNISH	_	A	2"X4"	WD	STAIN VARNISH	1HR	HS-1	YES	YES	YES	YES	_	+
D14	CUSTOMS X-RAY AREA	I	(2) 2'-6"	6'-8"	1-3/4"	нм	PT-SPRAYED WITH ENAMEL	LEADED GLASS	A	2"X4"	нм	PT-SPRAYED WITH	1HR	HS-2	YES	YES	YES	YES	_	DC
D14.1	CUSTOMS X-RAY AREA	н	3'-0"	6'-8"	1-3/4"	НМ	PT-SPRAYED WITH ENAMEL	LEADED	A	2"X4"	НМ	ENAMEL PT-SPRAYED WITH	1HR	HS-2	YES	YES	YES	YES	_	DC
D16	STORAGE	н	3'-0"	6'-8"	1-3/4"	нм	PT-SPRAYED		A	2"X6"	нм	ENAMEL PT-SPRAYED WITH	1HR	HS-2	YES	YES	YES	YES		
							WITH ENAMEL	-				ENAMEL PT-SPRAYED							-	+
D17	STORAGE	н	(2) 3'-0"	6'-8"	1-3/4"	нм	WITH ENAMEL	-	A	2"X6"	НМ	WITH ENAMEL PT-SPRAYED		HS-3	YES	YES	YES	YES	-	+
D19	COMPLIANCE OFFICE	1	(2) 2'-6"	6'-8"	1-3/4"	HM WD/SOLID	WITH ENAMEL	-	A	2"X4"	HM	WITH ENAMEL STAIN	1HR	HS-2	-	YES	YES	YES	-	+
D20		A	3'-0"	6'-8"	1-3/4"	CORE	VARNISH	-	A	2"X4"	WD	VARNISH	1HR	HS-2	-	YES	YES	YES	-	+
D21	OPERATIONS MANAGERS OFFICE	A	3'-0"	6'-8"	1-3/4"	WD/SOLID CORE	STAIN VARNISH	-	A	2"X4"	WD	STAIN VARNISH	1HR	HS-2	-	YES	YES	YES	-	_
D22	CORRIDOR	н	3'-0"	6'-8"	1-3/4"	НМ	PT-SPRAYED WITH ENAMEL	-	A	2"X4"	НМ	PT-SPRAYED WITH ENAMEL	1HR	HS-1	YES	YES	YES	YES	-	_
D23	VESTIBULE	A	3'-0"	6'-8"	1-3/4"	WD/SOLID CORE	STAIN VARNISH	-	A	2"X4"	WD	STAIN VARNISH	1HR	HS-1	YES	YES	YES	YES	-	
D24	AIRMAIL ROOM	I	(2) 2'-6"	6'-8"	1-3/4"	НМ	PT-SPRAYED WITH ENAMEL	-	А	2"X4"	нм	PT-SPRAYED WITH ENAMEL	1HR	HS-2	YES	YES	YES	YES	-	
D25	FILE STORAGE	А	3'-0"	6'-8"	1-3/4"	WD/SOLID CORE	STAIN VARNISH	-	А	2"X4"	WD	STAIN VARNISH	1HR	HS-2	YES	YES	YES	YES	-	
D27	REGISTRATION ROOM	I	(2) 2'-6"	6'-8"	1-3/4"	НМ	PT-SPRAYED WITH ENAMEL	-	A	2"X4"	НМ	PT-SPRAYED WITH ENAMEL	1HR	HS-2	YES	YES	YES	YES	-	
D28	SECURE ROOM	н	3'-0"	6'-8"	1-3/4"	НМ	PT-SPRAYED WITH ENAMEL	-	A	2"X4"	нм	PT-SPRAYED WITH ENAMEL	1HR	HS-9	YES	YES	YES	YES	_	
D29	MEETING ROOM	A	3'-0"	6'-8"	1-3/4"	WD/SOLID CORE	STAIN VARNISH	-	A	2"X4"	WD	STAIN VARNISH	1HR	HS-1	-	YES	YES	YES	_	
D29.1	MEETING ROOM	А	3'-0"	6'-8"	1-3/4"	WD/SOLID CORE	STAIN VARNISH	-	A	2"X4"	WD	STAIN VARNISH	1HR	HS-1	-	YES	YES	YES	-	
D34	CORRIDOR	н	3'-0"	6'-8"	1-3/4"	НМ	PT-SPRAYED WITH ENAMEL	-	A	2"X4"	нм	PT-SPRAYED WITH ENAMEL	1HR	HS-1	YES	YES	YES	YES	-	
D36	KITCHENETTE	F	3'-0"	6'-8"	1-3/4"	WD/SOLID CORE	STAIN VARNISH	-	A	2"X4"	WD	STAIN VARNISH	1HR	HS-2	-	YES	YES	YES	-	PC
D38	SHOWER	G	2'-8"	6'-8"	1-3/4"	WD/SOLID CORE	STAIN VARNISH	_	A	2"X4"	WD	STAIN VARNISH	1HR	HS-2	-	_	YES	_	_	t
D39	UNISEX	G	2'-8"	6'-8"	1-3/4"	WD/SOLID CORE	STAIN VARNISH	_	A	2"X4"	WD	STAIN VARNISH	1HR	HS-2	_	_	YES	_	_	+
	VESTIBULE	G	2'-8"	6'-8"	1-3/4"	WD/SOLID	STAIN		A	2"X4"	WD	STAIN	1HR	HS-2			YES			+



ITS	s	SET NO.	HARDWARE SET DESCRIPTION				
	-						
		HS-1					
			DESCRIPTION	MANUFACTURER	MODEL/SERIAL #	FINISH	NOTES
			PASSAGE LOCKSET	SCHLAGE	AL10S - JUPITER	626	
			HINGES	MCKINNEY	TA2314 - 4"X4"	STAINLESS STEEL	
			DOOR CLOSURE	LCN	4041 SERIES	ALUMINUM	
ACTION SPRING LOADED HINGES			DOOR FLOOR STOP (HALF DOME DOOR BUMPER)	BALDWIN	4000	264	
			DOOR SILENCER	IVES	SR66	GRAY	
	-	HS-2	HS2# INDICATES ADDITIONAL REQUIREMENT FOR SARGENT 10				<u></u>
	_	H3-2	LINE CYLINDRICAL LOCK (KEYPAD SERIES)	MANUFACTURER	MODEL/SERIAL #	FINISH	NOTES
					AL10S - JUPITER	626	
			HINGES		TA2314 - 4"X4"	STAINLESS STEEL	
					4041 SERIES		
DOOR WITH LOCKING MECHANISIM			DOOR FLOOR STOP (HALF DOME DOOR BUMPER)	BALDWIN	4000	264	
	-		DOOR SILENCER	IVES	SR66	GRAY	
		HS-3					1
/ LEAD CORE; DOOR FRAME W/ LEAD SHEILDING; WINDOW FRAME W/ LEAD			DESCRIPTION	MANUFACTURER	MODEL/SERIAL #	FINISH	NOTES
IG; LEADED GLASS			TOUCH BAR EXIT DEVICES	VON DUPRIN	99-27-L-16-F-LBR-3'-USB-(LHR OR RHR)	BRUSHED ALUMINUM	UL LISTEDD DEVICES
IG; LEADED GLASS			HINGES	MCKINNEY	T4A3386 - 4"X4"	STAINLESS STEEL	UL LISTEDD DEVICES
			DOOR CLOSURE	LCN	4041 SERIES	ALUMINUM	UL LISTEDD DEVICES
			DOOR FLOOR STOP (HALF DOME DOOR BUMPER)	BALDWIN	4000	264	UL LISTEDD DEVICES
			DOOR SILENCER	IVES	SR66	GRAY	UL LISTEDD DEVICES
		3'-4"	6'-4"	4'-4"		6'-4"	
	SOLID C W/ W		O.A. SIZE: 7"x30" 5%6" THICK FIRELITE GLASS 000R ME DOOR W/ WOODEN LEGEND:	E WOOD SOLID CORE WOO	D DOOR DOUB RAME DOOR	6'-0" O.A. SIZE: 7"x30" 5%6" THICK FIRELITE GLASS DOOR TYPE D LE SOLID CORE WOOD R W/ WOODEN FRAME; WINGS BOTH WAYS	
DOOR WITH LOCKING MECHANISIM	SOALE:	5'-4" 5'-0"	O.A. SIZE: 7"x30" 5_{16} " THICK FIRELITE GLASS C C C C C C C C	DOOR TYPE G	0.A. SIZE: 7"x30" 5%6" THICK FIRELITE GL DOOR TYPE H HOLLOW METAL DOOR W/	ASS	0.A. SIZE: 7"x30" 5%6" THICK FIRELITE GLA

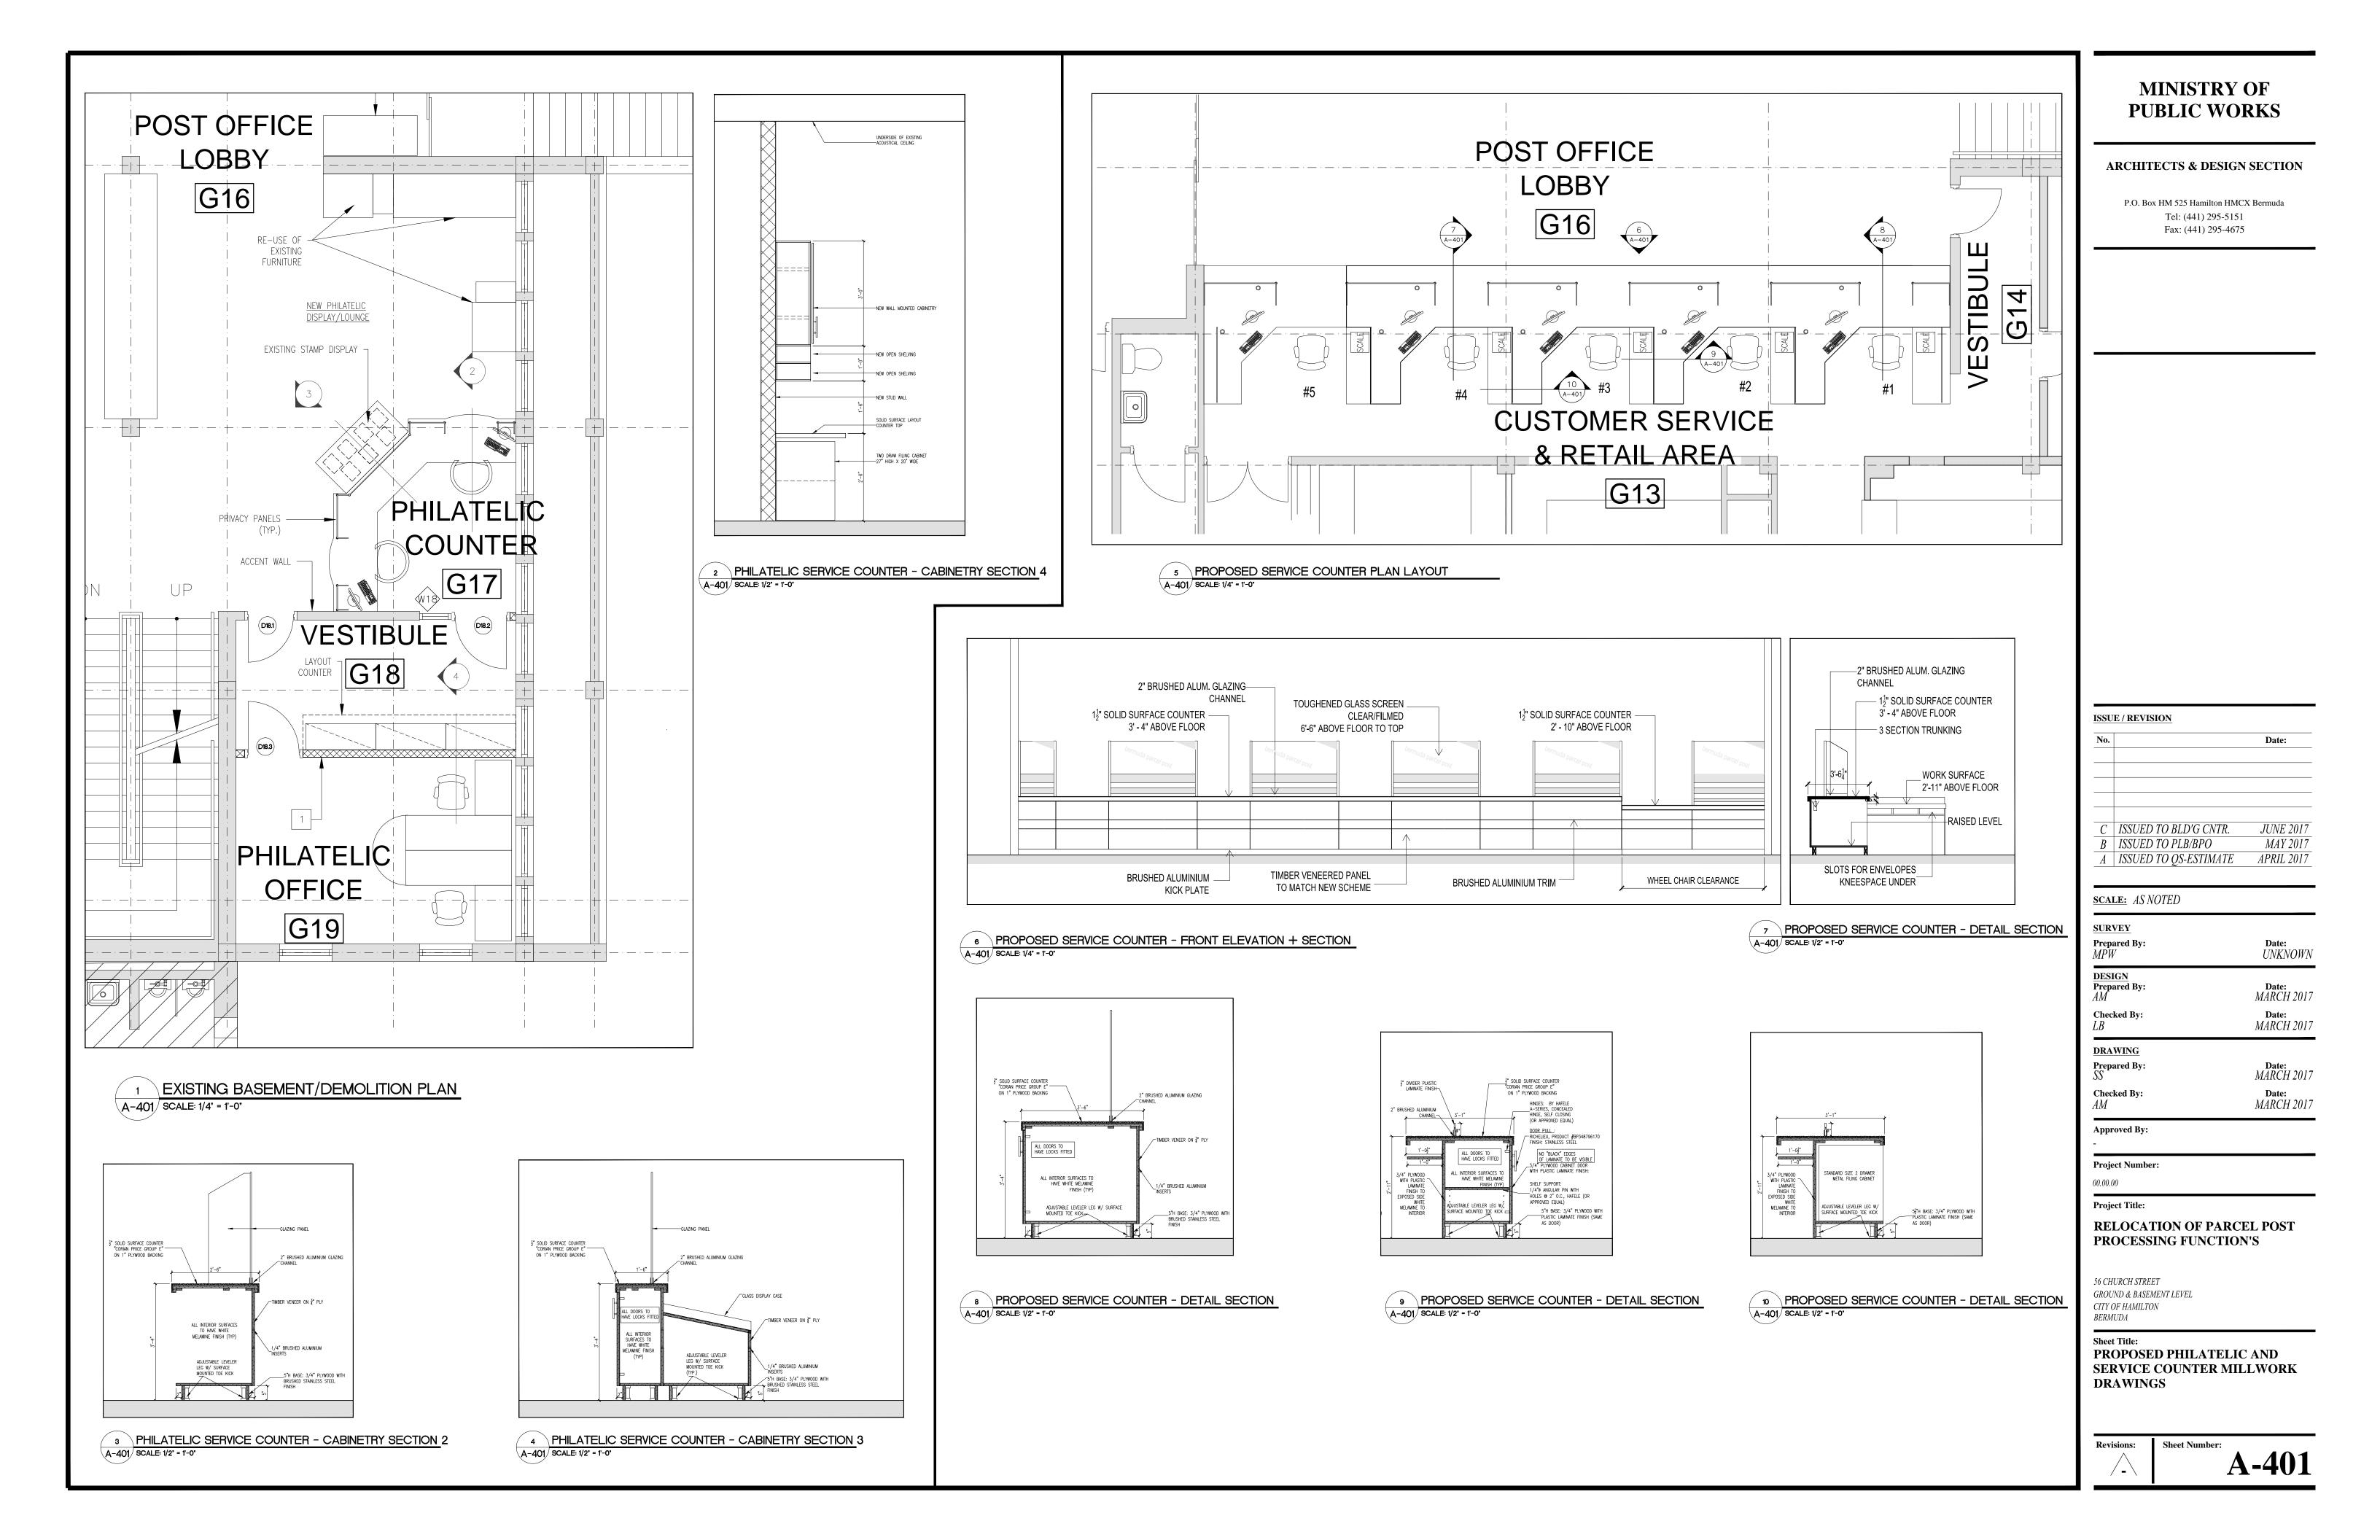MINISTRY OF PUBLIC WORKS

ARCHITECTS & DESIGN SECTION
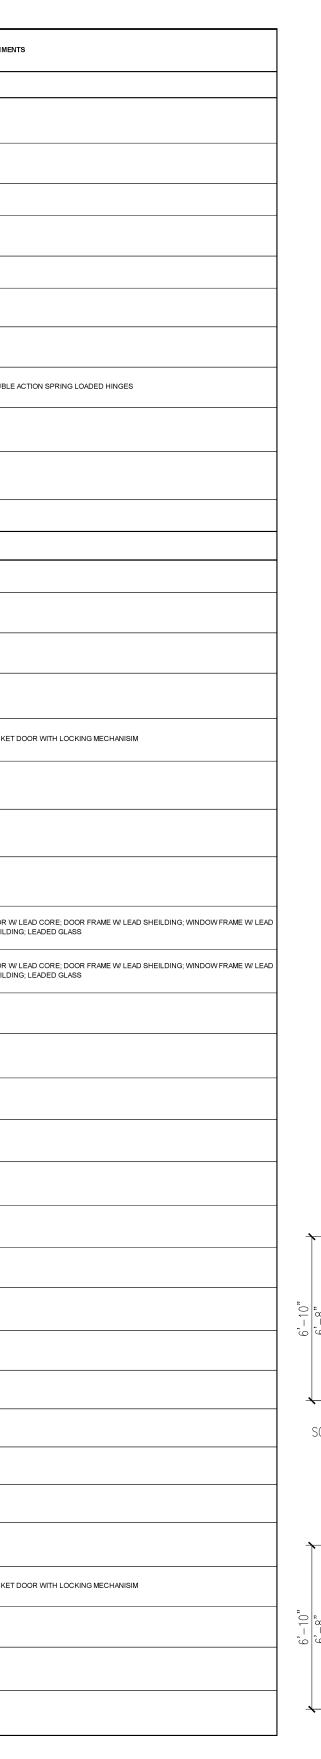
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B ISSUED TO PLB/BPO	MAY 2017
A ISSUED TO QS-ESTIMATE	APRIL 2017
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PROCESSING FUNCTION'S

56 CHURCH STREET

CITY OF HAMILTON BERMUDA

Sheet Title:


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GROUND & BASEMENT LEVEL


DOOR SCHEDULE


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DRAWING	
Prepared By:	Date:
SS	MARCH 2017
Checked By:	Date:
AM	MARCH 2017

Approved By:

ISSUE / REVISION

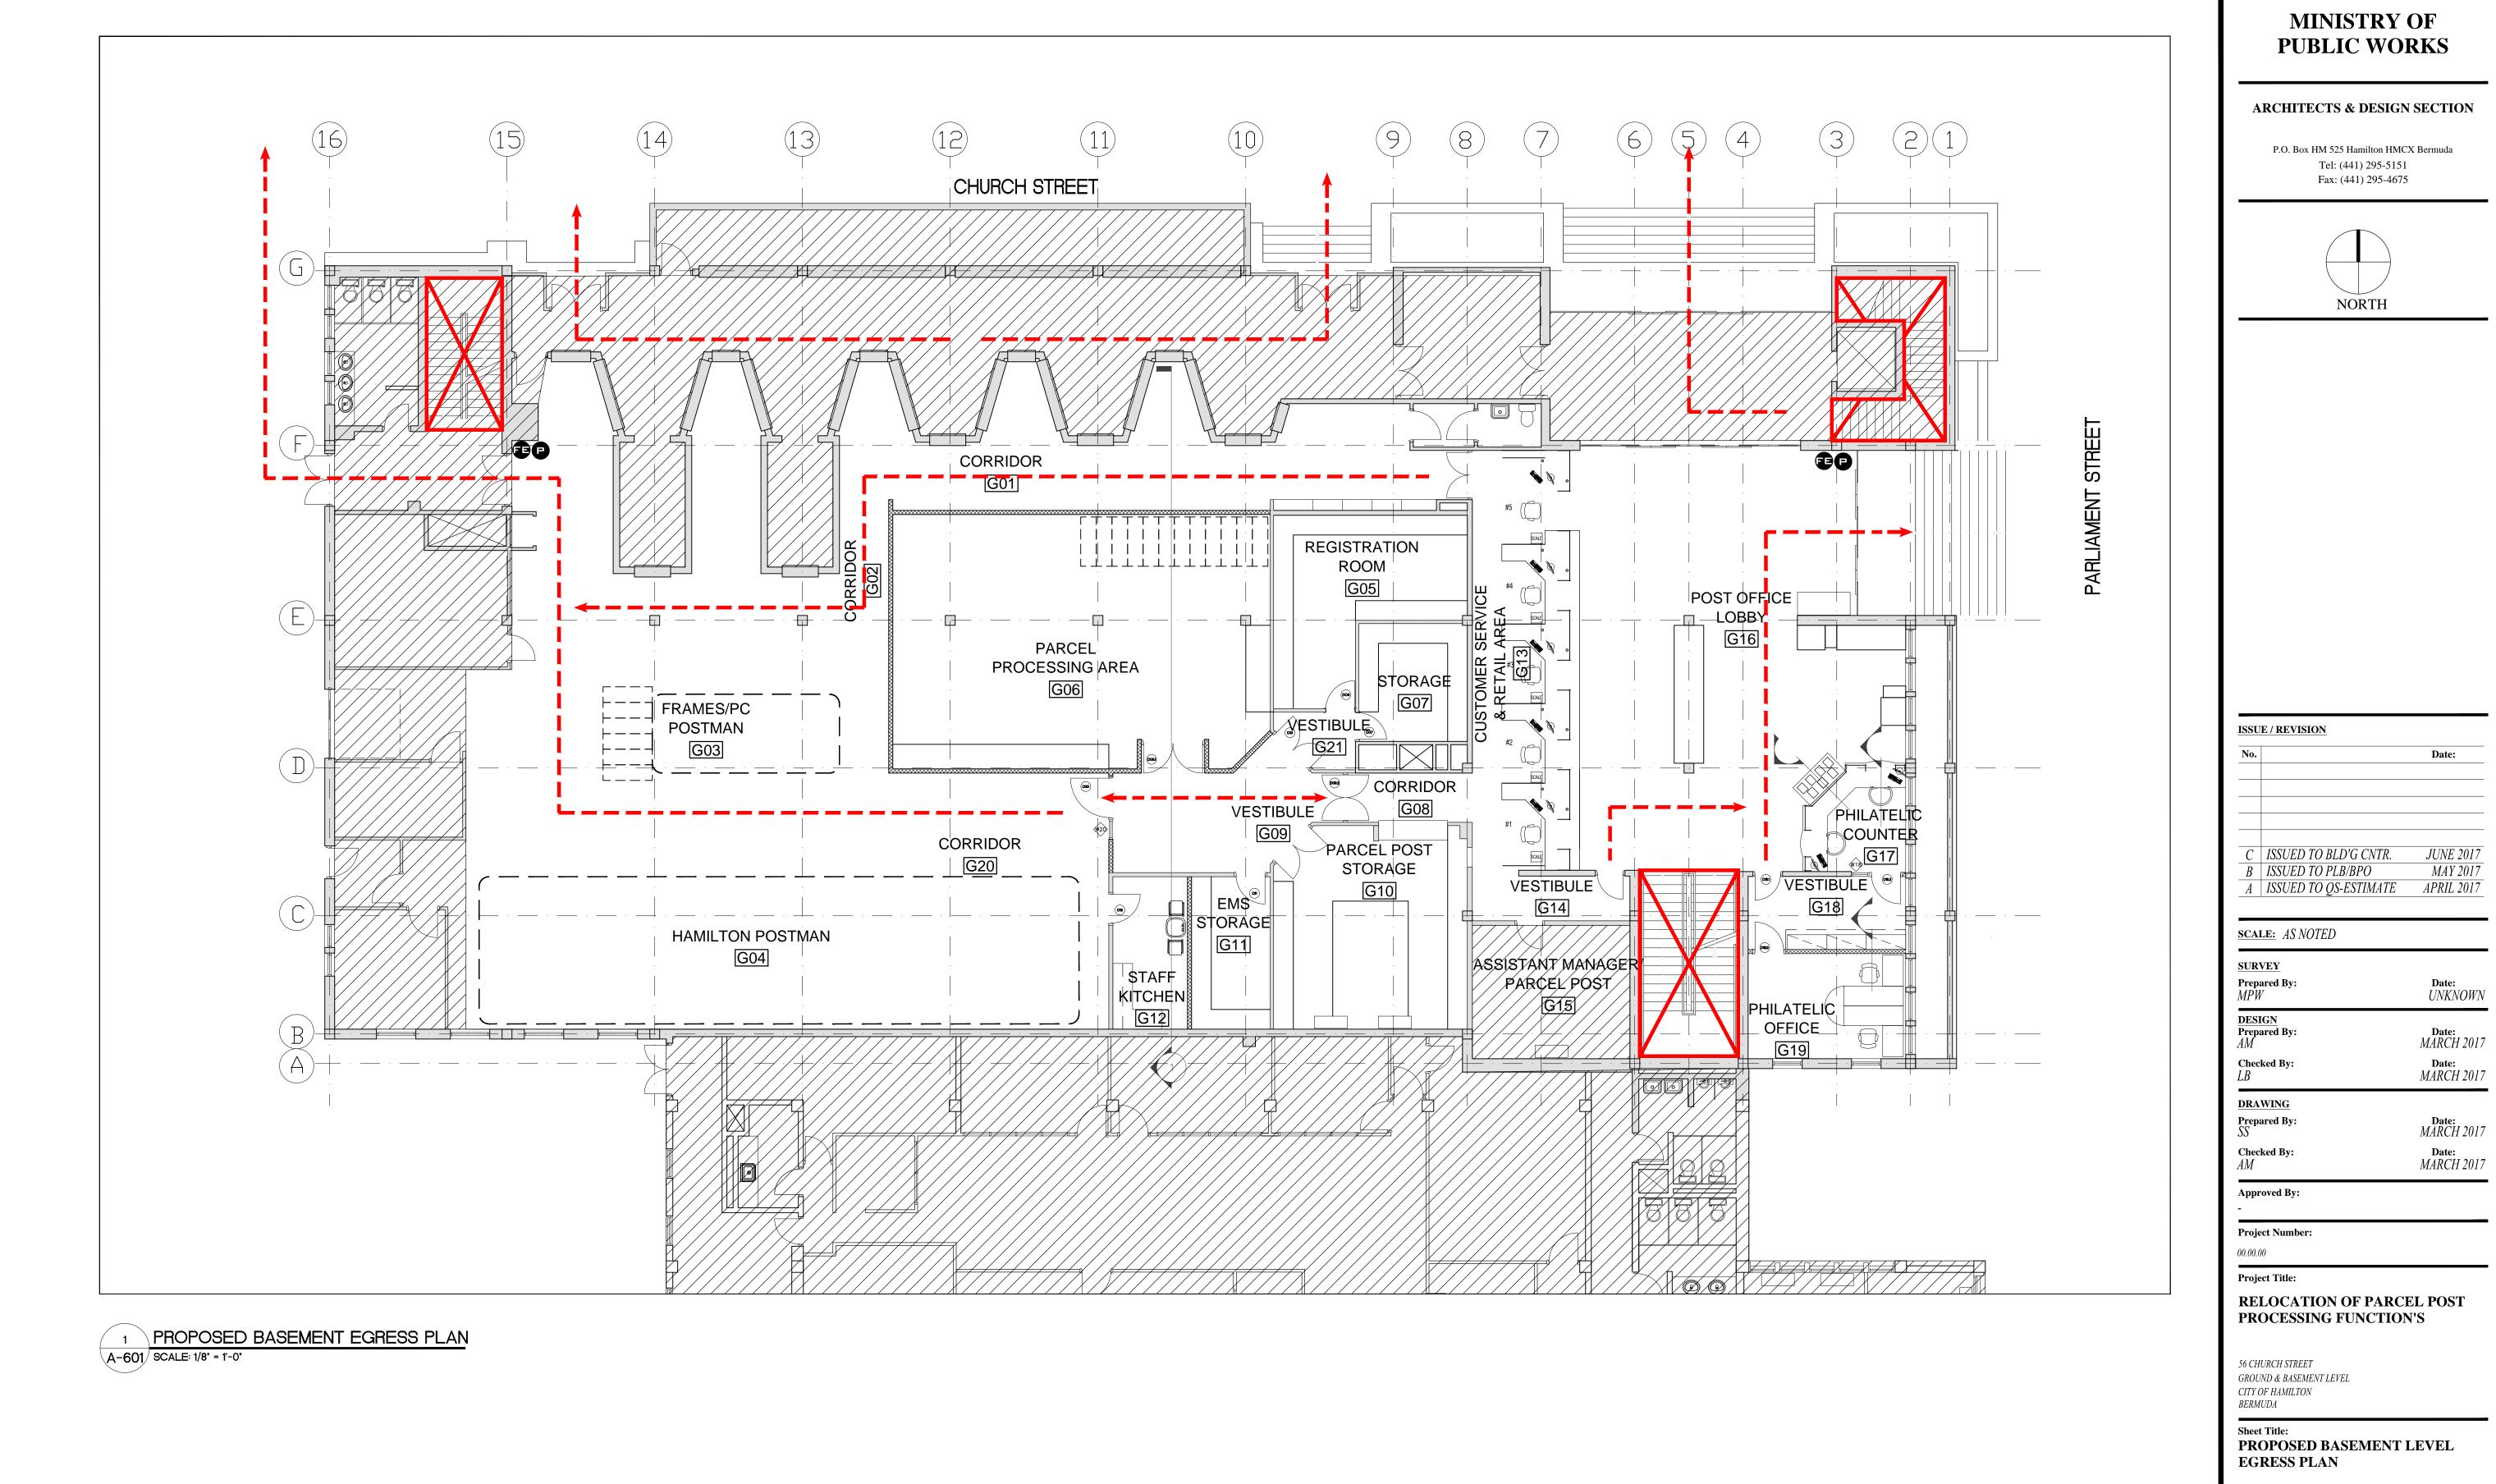Project Number:
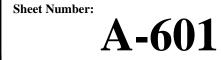
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Project Title:

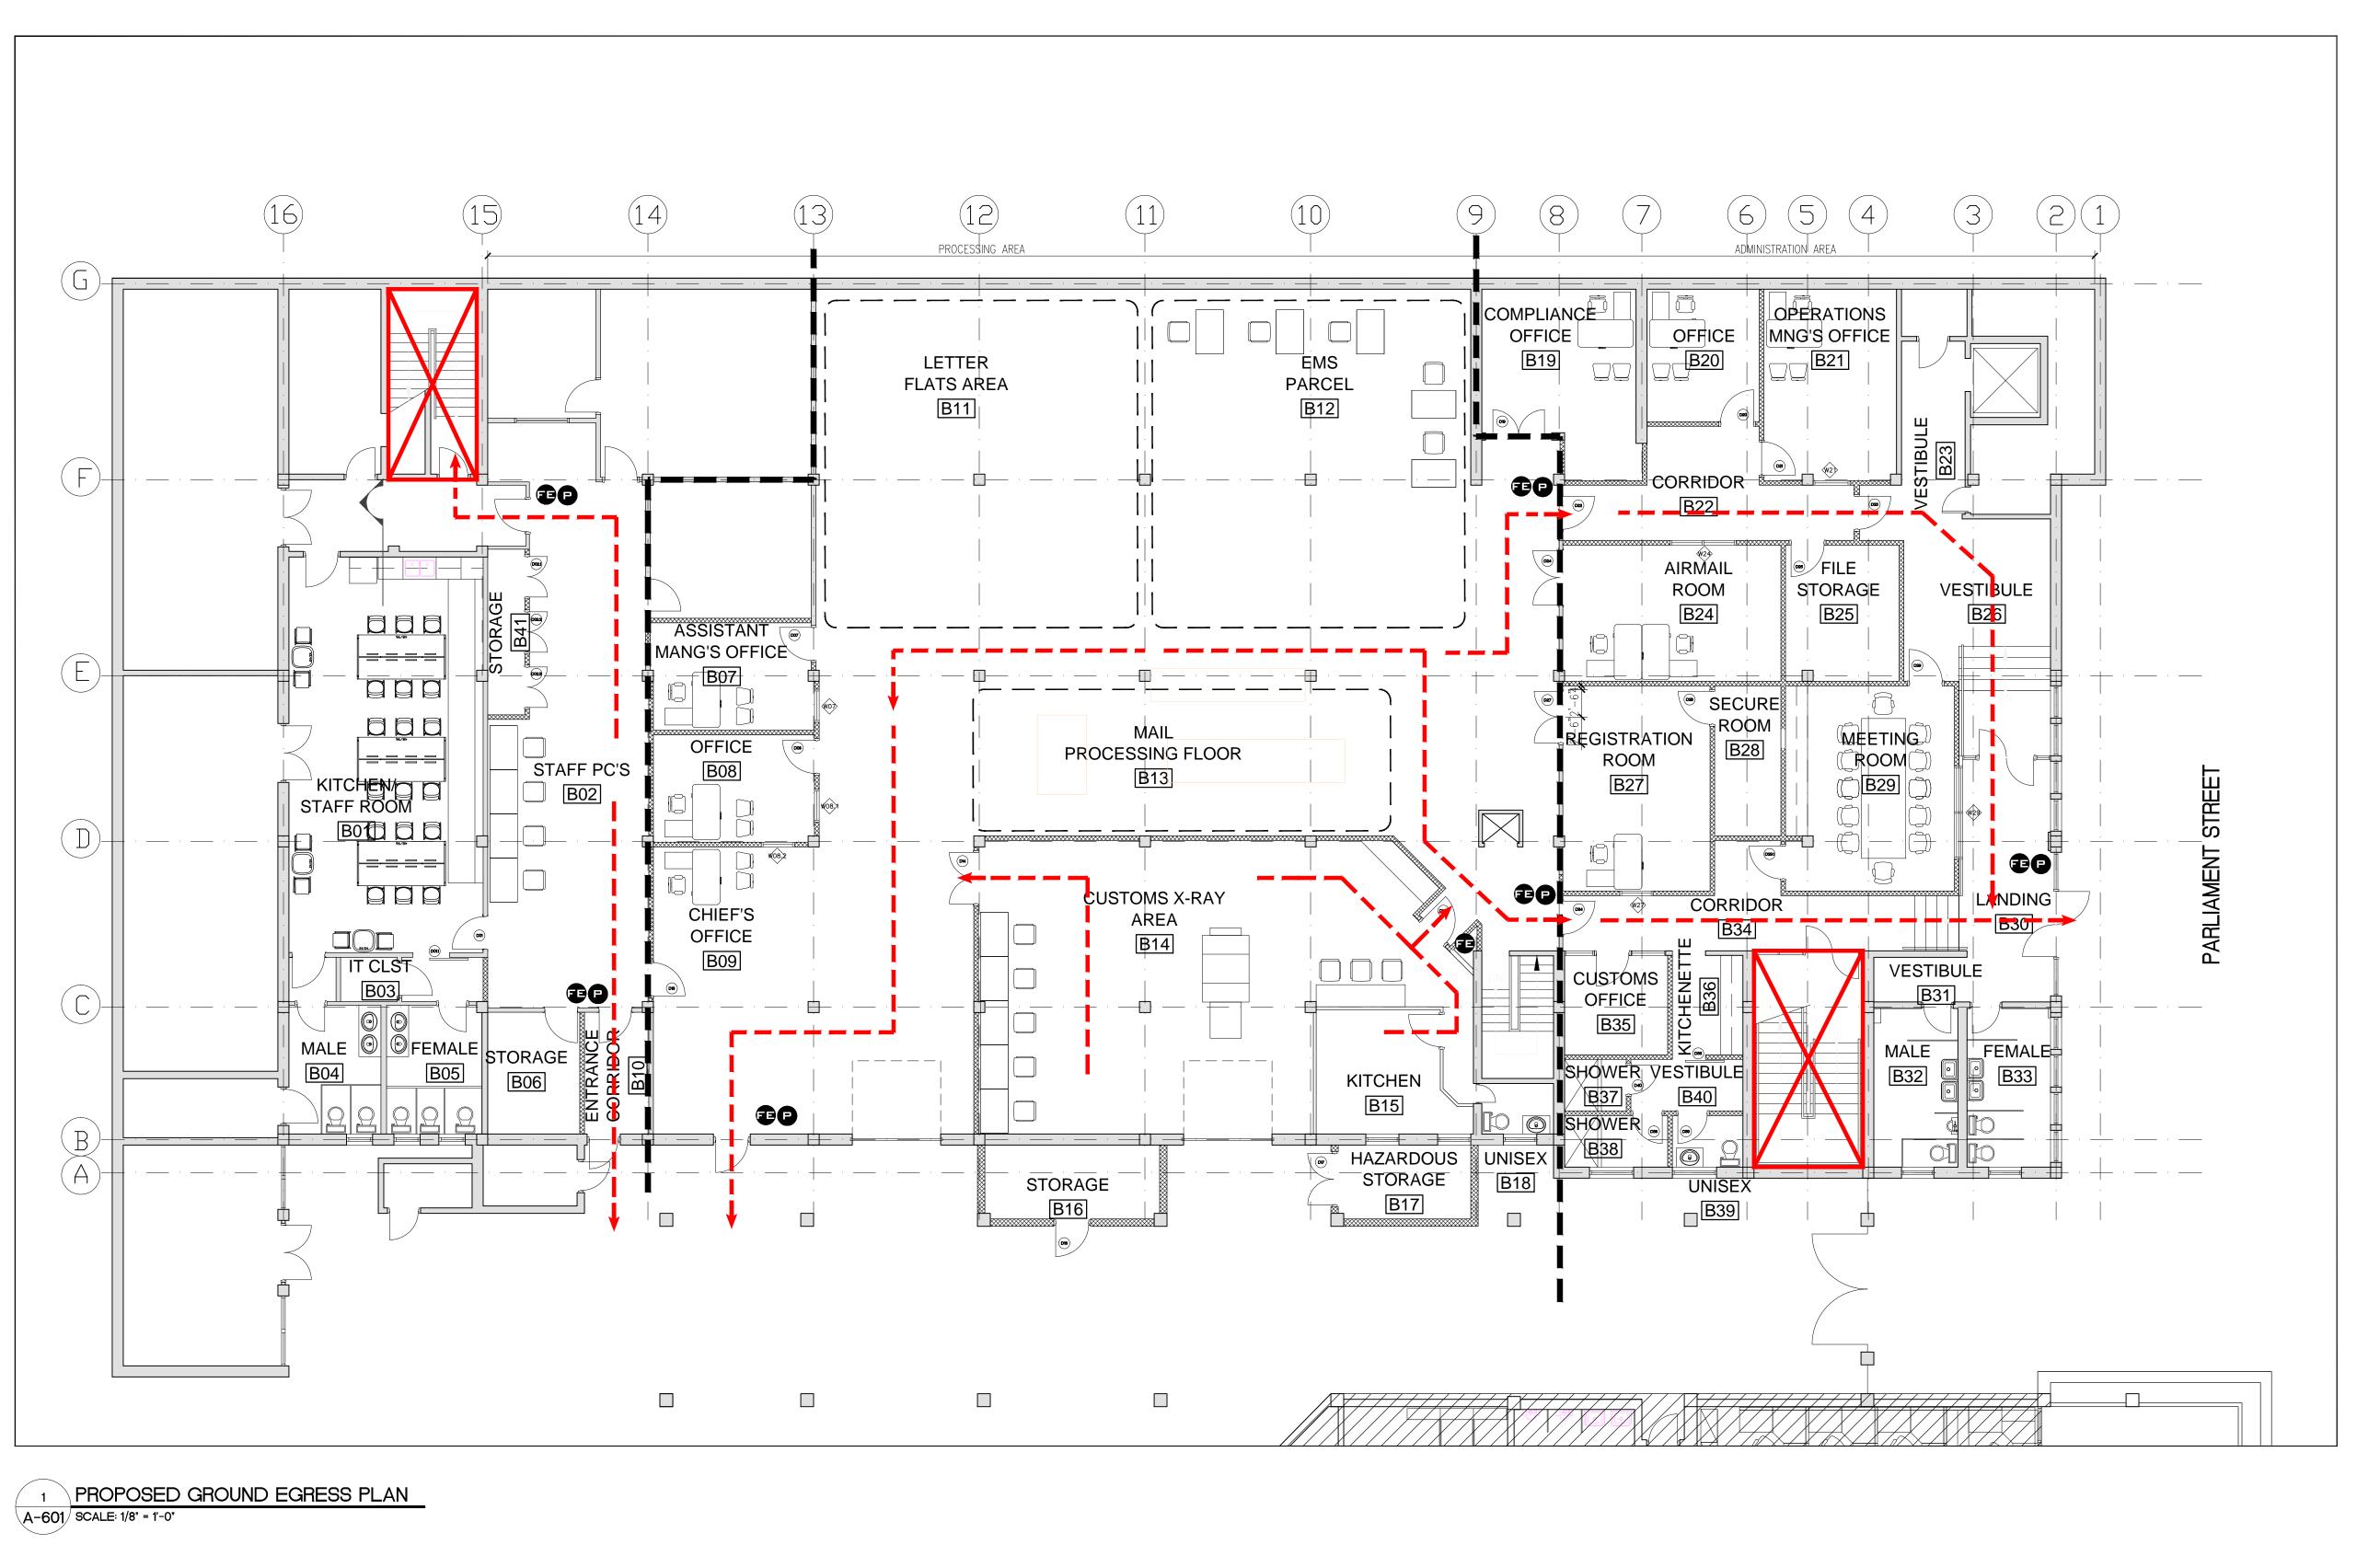RELOCATION OF PARCEL POST PROCESSING FUNCTION'S

56 CHURCH STREET GROUND & BASEMENT LEVEL CITY OF HAMILTON BERMUDA

Sheet Title:

PROPOSED GROUND LEVEL EGRESS PLAN

Revisions: ____

